SU-8-106-M909-M1014

OVERFLOW PARKING PROJECT for

PORT CITY COMMUNITY CHURCH

250 VISION DRIVE Wilmington, North Carolina

General Notes:

- 1. Prior to any clearing, grading, or construction activity, tree protection fencing will be installed around protected trees or groves of trees and no construction workers, materials, or vehicles are permitted within the tree protection fencing
- 2. All pavement markings in public rights-of-way and for driveways are to be thermoplastic and meet City and/or
- Once streets are open to traffic, contact Traffic Engineering to request installation of traffic and street name signs.
 Proposed street names must be approved prior to installation of street name signs.
- 4. Traffic control devices (including signs and pavement markings) in areas open to public traffic are to meet MUTCD (Manual on Uniform Traffic Control Devices) standards.
- 5. Contact Traffic Engineering at 341-7888 to ensure that all traffic signals facilities and equipment are shown on the plan. Add a note to call Traffic Engineering at 341-7888 forty-eight hours prior to any excavation in the right-of-way.
- 6. Any broken or missing sidewalk panels, driveway panels and curbing will be replaced.
- Contact TRAFFIC ENGINEERING at 341-7888 to discuss street lighting options.
- 8. Project shall comply with the CFPUA Cross Connection Control requirements. Water meter(s) cannot be released until all requirements are met and the State has given their Final Approval. Call 332-6419 for information.
- 9. If the contractor desires CFPUA water for construction he shall apply in advance for this service and must provide a reduced pressure zone (RPZ) backflow prevention device on the developer's side of the water meter box.
- 10. Any irrigation system supplied by CFPUA water shall comply with the CFPUA's Connection Control regulations. Call 332-6419 for information.
- 11. Any backflow prevention devices required by the CFPUA will need to be on the list of approved devices for USCFCCCHR or ASSE.
- 12. A Landscaping Plan indicating the location of required street trees shall be submitted to the City of Wilmington Traffic Engineering Division and the Parks and Recreation Department for review and approval prior to the recording of the final plat.
- 13. Permitting of business identification signage is a separate process. NCDOT/City of Wilmington will not allow obstructions within the righ of way.
- 14. Prior to any clearing, grading or construction activity, tree protection fencing will be installed around protected trees or groves of trees and no construction workers, tools, materials or vehicles are permitted within the tree protection fencing.
- 15. All traffic control signs and markings off the right-or-way are to be maintained by the property owner in accordance with MUTCD standards.
- 16. Install reflectors per City and NCDOT standards. Traffice Engineering must approve of pavement marking layout prior to actual striping.
- 17. All parking stall markings and lane arrows within parking areas shall be white.

DEVELOPER:

PORT CITY COMMUNITY CHURCH 250 VISION DRIVE WILMINGTON, NC 28403 PHONE: 910-202-8800

OWNER:

PORT CITY COMMUNITY CHURCH 250 VISION DRIVE WILMINGTON, NC 28403 PHONE: 910-202-8800

PHONE: 910-202-8800
richie.marshall@portcitychurch.org

DESIGNER:



Coastal Land Design, PLLC

Civil Engineering / Landscape Architecture
Land Planning / Construction Management


NCBELS Firm License No: P-0369

O Box 1172

Phone: 910-254-

P.O.Box 1172 Phone: 910-254-9333 Wilmington, NC 28402 www.cldeng.com Fax: 910-254-0502



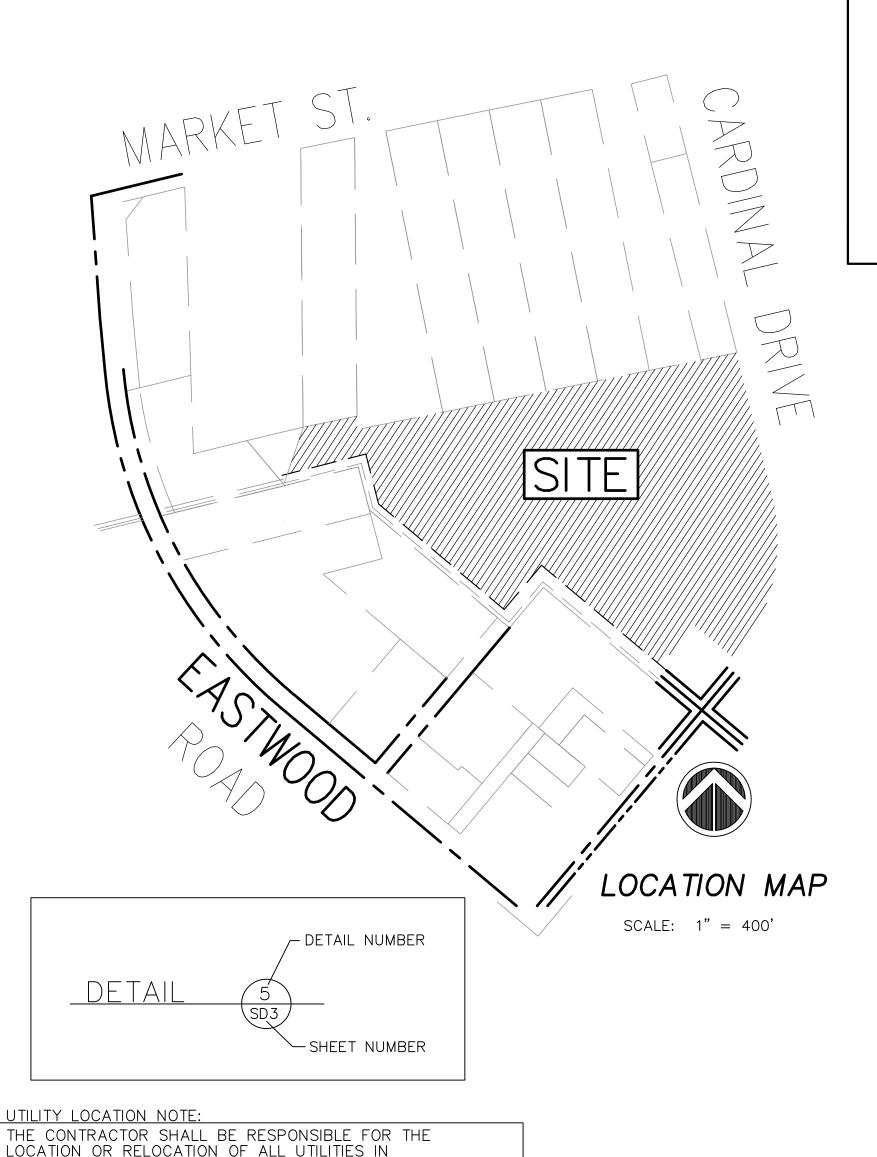

COORDINATION WITH THE APPROPRIATE UTILITY AGENCY

OR 811 BEFORE DIGGING.

OR COMPANY. THE CONTRACTOR IS REQUIRED TO CALL

THE "NORTH CAROLINA ONE CALL CENTER" 1-800-632-4949

INDEX

MASTER PLAN SD-2EXISTING CONDITIONS - TREE REMOVAL SITE PLAN TREE REMOVAL PLAN LAYOUT PLAN GRADING PLAN LANDSCAPE SD-8LANDSCAPE SHADING AND DETAIL SD-9SITE DETAILS SD-10 SITE DETAILS SD-11STORMWATER PLAN SD-12 SITE LIGHTING PLAN

For each open utility
cut of
City streets, a \$325
permit
shall be required from
the
City prior to occupancy
and/or project

acceptance.



WILMINGTON NORTH CAROLINA						
Approved Constr	uction Plan					
<u>Name</u>	<u>Date</u>					
Plann <u>ing</u>						
Tra <u>ffic</u>						
Fire						

CITY COUNCIL/PLANNING BOARD CONDITIONS:

SU-8-106-M909-M1014

- I. THE APPLICANT SHALL FULLY COMPLY WITH ALL OF THE SPECIFIC REQUIREMENTS
 STATED IN THE LAND DEVELOPMENT CODE FOR THE PROPOSED USE AS WELL AS
- 2. IF ANY SECTION, SUBSECTION, PARAGRAPH, SENTENCE, CLAUSE, PHRASE OR PORTION OF THIS PERMIT IS FOR ANY REASON HELD INVALID OR UNCONSTITUTIONAL BY ANY COURT OF COMPETENT JURISDICTION, THIS SPECIAL USE PERMIT SHALL BE NULL AND YOLD AND OF NO FEECT.
- THE USE AND DEVELOPMENT OF THE SUBJECT PROPERTY SHALL BE IN ACC
- 4. THE USE AND DEVELOPMENT OF THE SUBJECT PROPERTY SHALL COMPLY WITH ALL OTHER SUPPLEMENTAL REGULATIONS AND REQUIREMENTS IMPOSED BY THE LAND DEVELOPMENT CODE OR ANY OTHER APPLICABLE FEDERAL, STATE OR LOCAL LAW, ORDINANCE OR REGULATION. IN THE EVENT OF A CONFLICT, THE MORE STRINGENT OR HIGHER STANDARD SHALL APPLY.
- 5. DURING TIMES OF VEHICULAR STORAGE IN THE GRASSED AREAS, THE PARKING AISLES SHALL BE DELINEATED.
- 6. TREE CLEARING SHALL BE LIMITED TO ESSENTIAL SITE IMPROVEMENTS WITHIN THE PROJECT LIMITS AS SHOWN ON THE APPROVED SITE PLAN. MITIGATION OF PERSERVED TREES WILL BE ENFORCED. TREES OUSIDE THE PROJECT LIMITS OF DISTURBANCE WILL BE PROTECTED DURING THIS PHASE OF CONSTRUCTION.
- 7. THE SITE SHALL BE DEVELOPED IN ACCORDANCE WITH THE APPROVED SITE PLAN.
- 8. ALL SIGNAGE FOR THE PROJECT SHALL BE NON-ILLUMINATED.9. ALL OUTDOOR LIGHTING SHALL BE INSTALLED SO AS NOT TO SHINE OR REFLECT
- DIRECTLY ONTO SURROUNDING PROPERTIES.

 10. A PORTION OF VISION DRIVE THAT BISECTS THE PROPERTY SHALL BECOME A PUBLIC THROUGH-STREET TO BRING THE DEVELOPMENT INTO COMPLIANCE WITH THE 500 FEET AND 800 FEET LENGTH LIMITS AS SPECIFIED IN THE TECHNICAL
- I I . ALL CITY, STATE AND FEDERAL REGULATIONS SHALL BE MET.
- 12. ALL TECHNICAL REVIEW COMMITTEE COMMENTS SHALL BE FOLLOWED.

 OF THE PROPOSED 291 PARKING SPACES, AT LEAST 50 PERCENT OF THOSE SPACES MUST BE OF PERVIOUS MATERIAL. DRIVE AISLES WITHIN THE PROPOSED PARKING LOT CAN BE PAVED WITH IMPERVIOUS MATERIALS.

SU-8-106-M909


1. GEORGE TRASK DRIVE IS EXTENDED AS A PUBLIC ROAD FROM CARDINAL DRIVE CONNECTING TO VISION DRIVE. THE PRIVATE ACCESS ROAD BETWEEN CARDINAL DRIVE AND VISION DRIVE/GEORGE TRASK DRIVE INTERSECTION SAHLL BE CONSTRUCTED TO CITY PUBLIC STREET STANDARDS FOR COLLECTOR STREETS. IF THE REMAINDER OF THE PROPERTY NORTH OF THE PORT CITY COMMUNITY CHURCH PROJECT IS DEVELOPED FOR ANY USE OTHER THAN A RELIGIOUS INSTITUTION, THEN THE PRIVATE ACCESS ROAD SHALL BECOME A PUBLIC STREET PRIOR TO ANY ZONING PERMIT BEING ISSUED. THIS APPROVAL DOES NOT RELIEVE THE CHURCH FROMA VARIANCE FROM THE CITY OF WILMINGTON'S TECHNICAL STANDARDS AND SPECIFICATIONS MANUAL REGARDING DRIVEWAY LENGTHS IF THE REMAINDER OF THE PROPERTY NORTH OF THE PORT CITY COMMUNITY CHURCH PROJECT IS DEVELOPED AS AN EXTENSION OF THE CHRUCH CAMPUS.


2. ALL SIGNAGE FOR THE PROJECT SHALL BE NON-

3. ALL OUTDOOR LIGHTING SHALL BE INSTALLED SO AS NOT TO SHINE OR REFLECT DIRECTLY ONTO SURROUNDING

4. THE DEVELOPER SHALL PROVIDE APPROPRIATE EASEMENTS FOR MUNICIPAL AND NON-MUNICIPAL UTILITIES.
5. A TREE REMOVAL PERMIT AND LANDSCAPING PLAN SHALL BE REQUIRED PRIOR TO RELEASE OF THE PROJECT FOR CONSTRUCTION.

6. FOLLOW THE REQUIREMENTS OF THE TIA.
7. TREES DESIGNATED TO BE PRESERVED MUST BE PROPERLY PROTECTED DURING CONSTRUCTION.
8. ALL MISSING OR BROKEN SIDEWALK PANELS SHALL BE REPLACED.

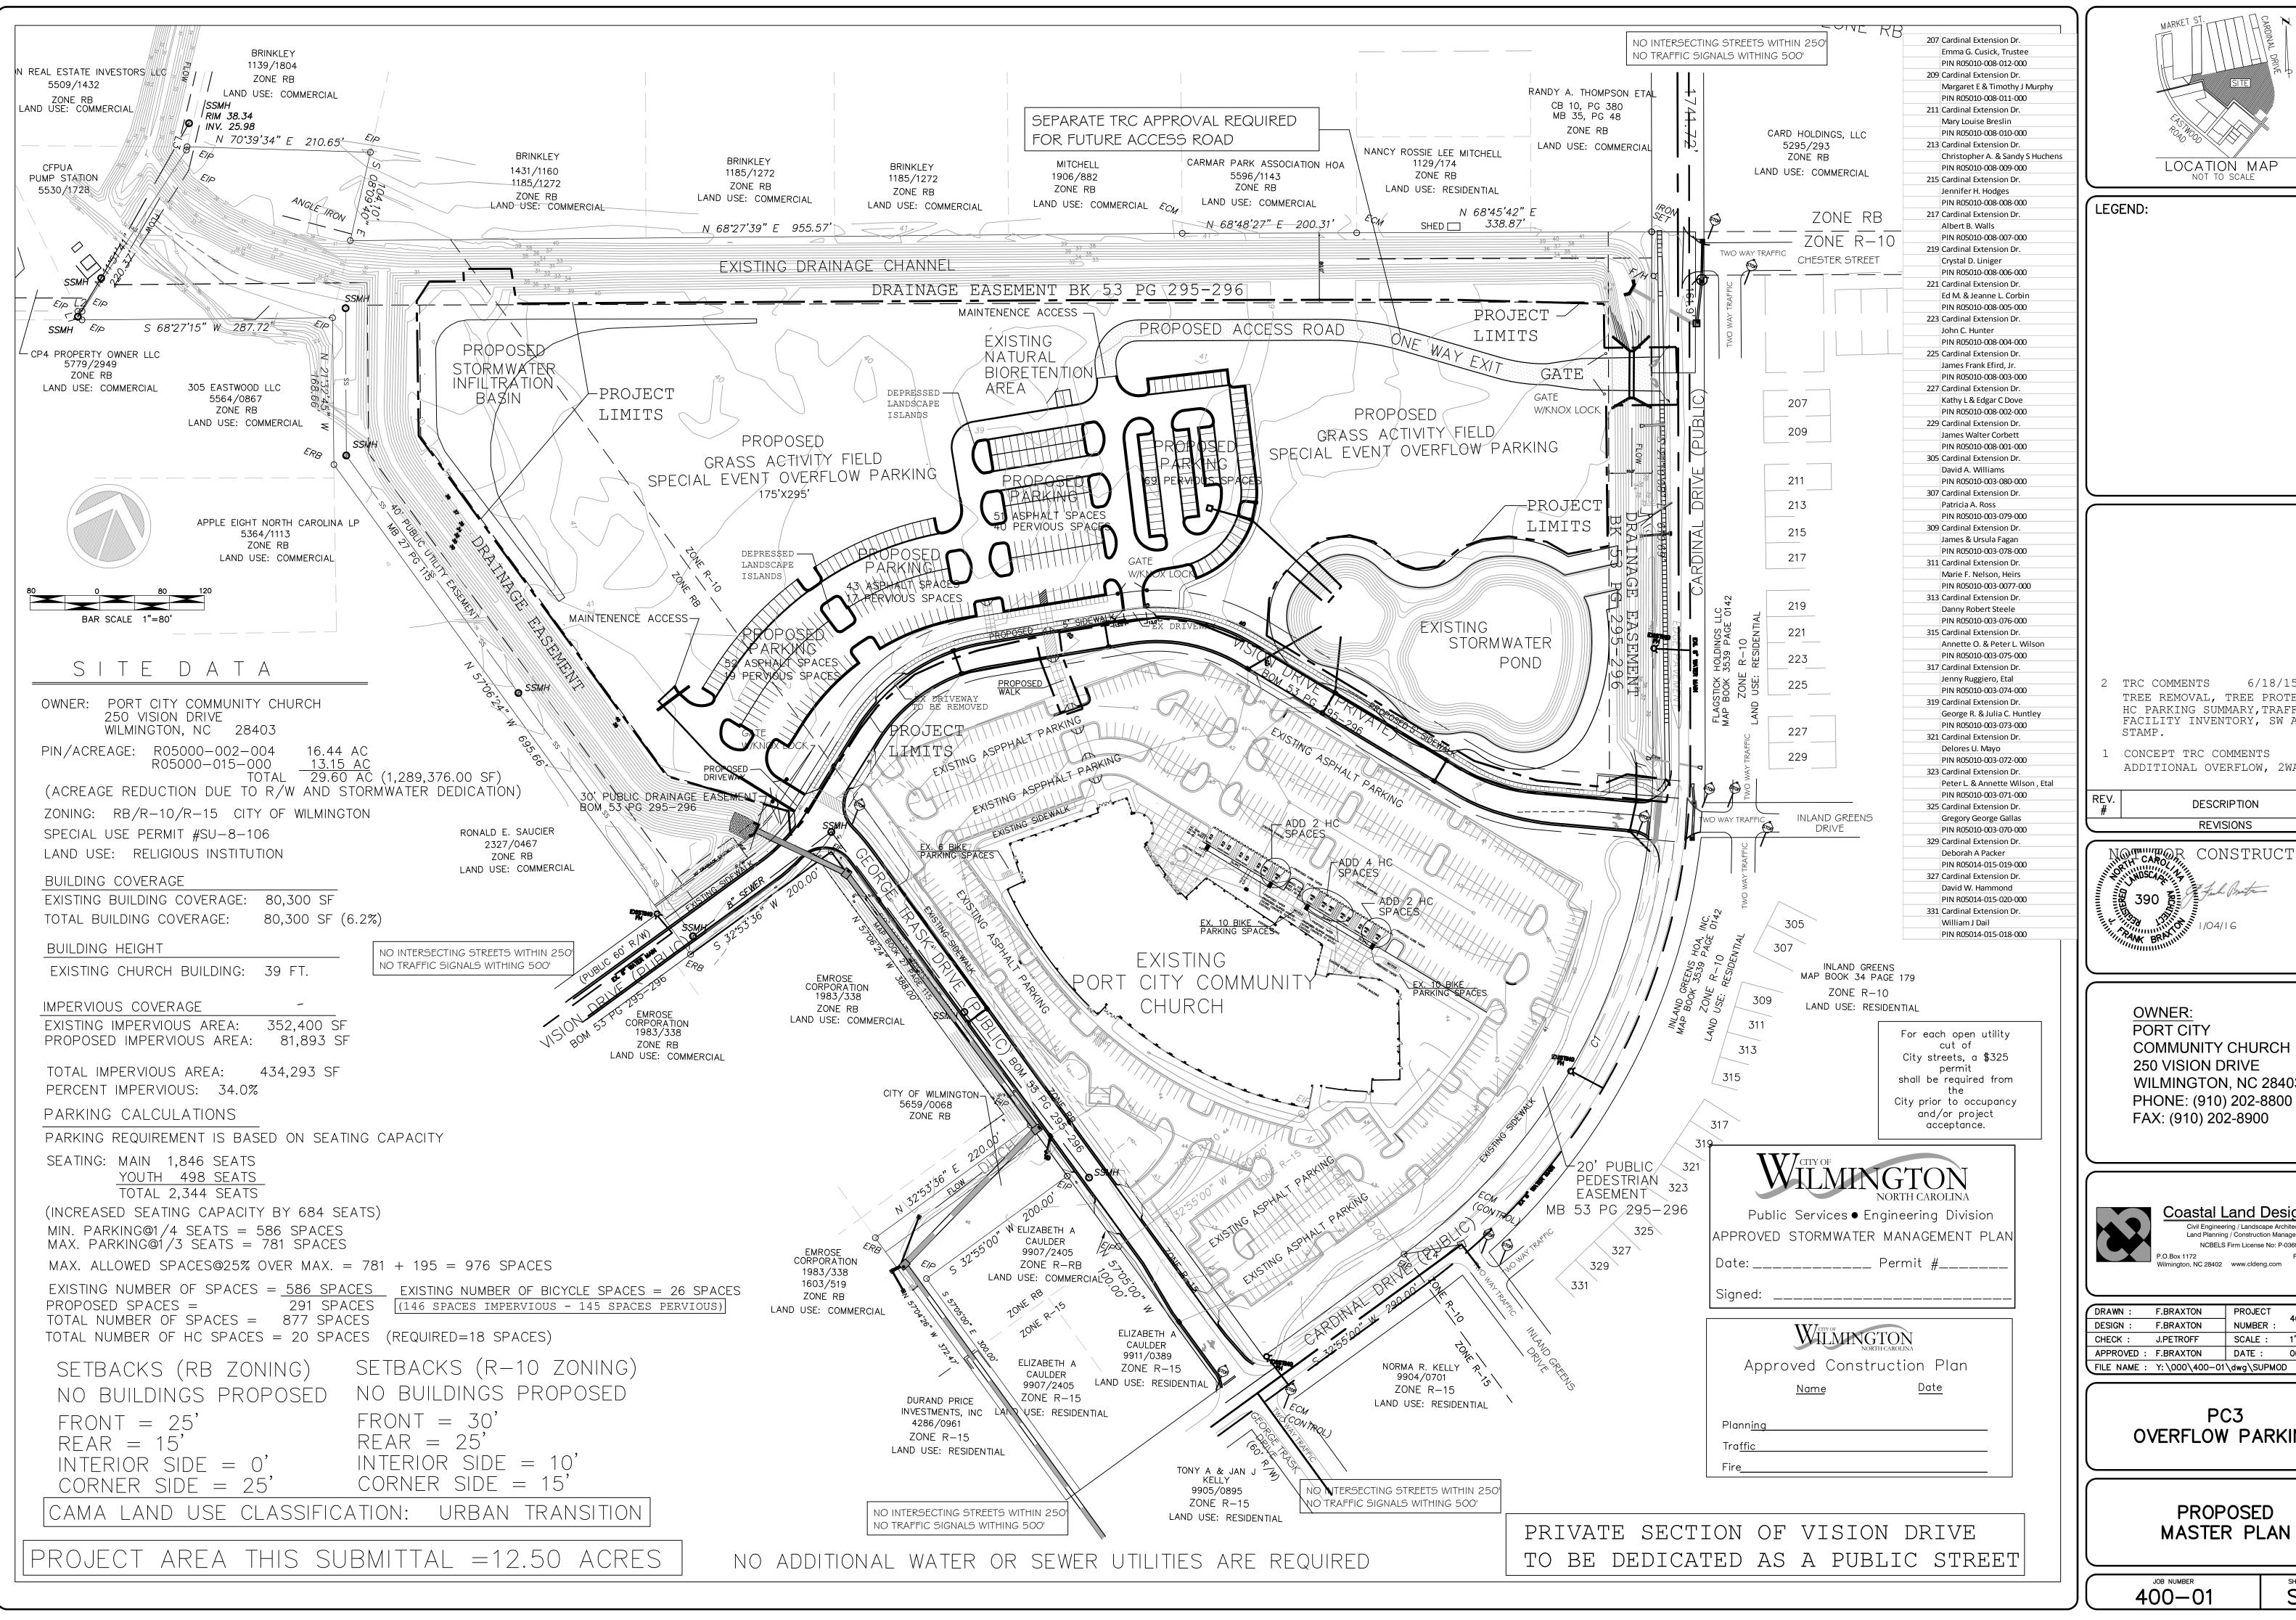

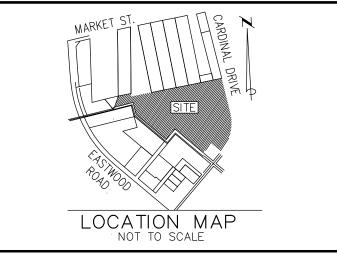

TRC COMMENTS 6/18/15 TREE REMOVAL, TREE PROTECTION, HC PARKING SUMMARY, TRAFFIC FACILITY INVENTORY, SW APPROVAL CONCEPT TRC COMMENTS ADDITIONAL OVERFLOW, 2WAY DRIVE REV.BY DATE

CONSTRUCTION CONSTRUCTION


COMMUNITY CHURCH WILMINGTON, NC 28403 PHONE: (910) 202-8800 FAX: (910) 202-8900

Coastal Land Design, PLLC Civil Engineering / Landscape Architecture Land Planning / Construction Management NCBELS Firm License No: P-0369

	DRAWN:	F.BRAXTON	PROJECT	400-01	,
	DESIGN :	F.BRAXTON	NUMBER :	400-01	
	CHECK :	J.PETROFF	SCALE :	1"=80'	
	APPROVED :	F.BRAXTON	DATE:	06/18/14	
	FILE NAME :	Y: \000\400-01	\dwg\SUPMO[)	
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OVERFLOW PARKING

SD-1

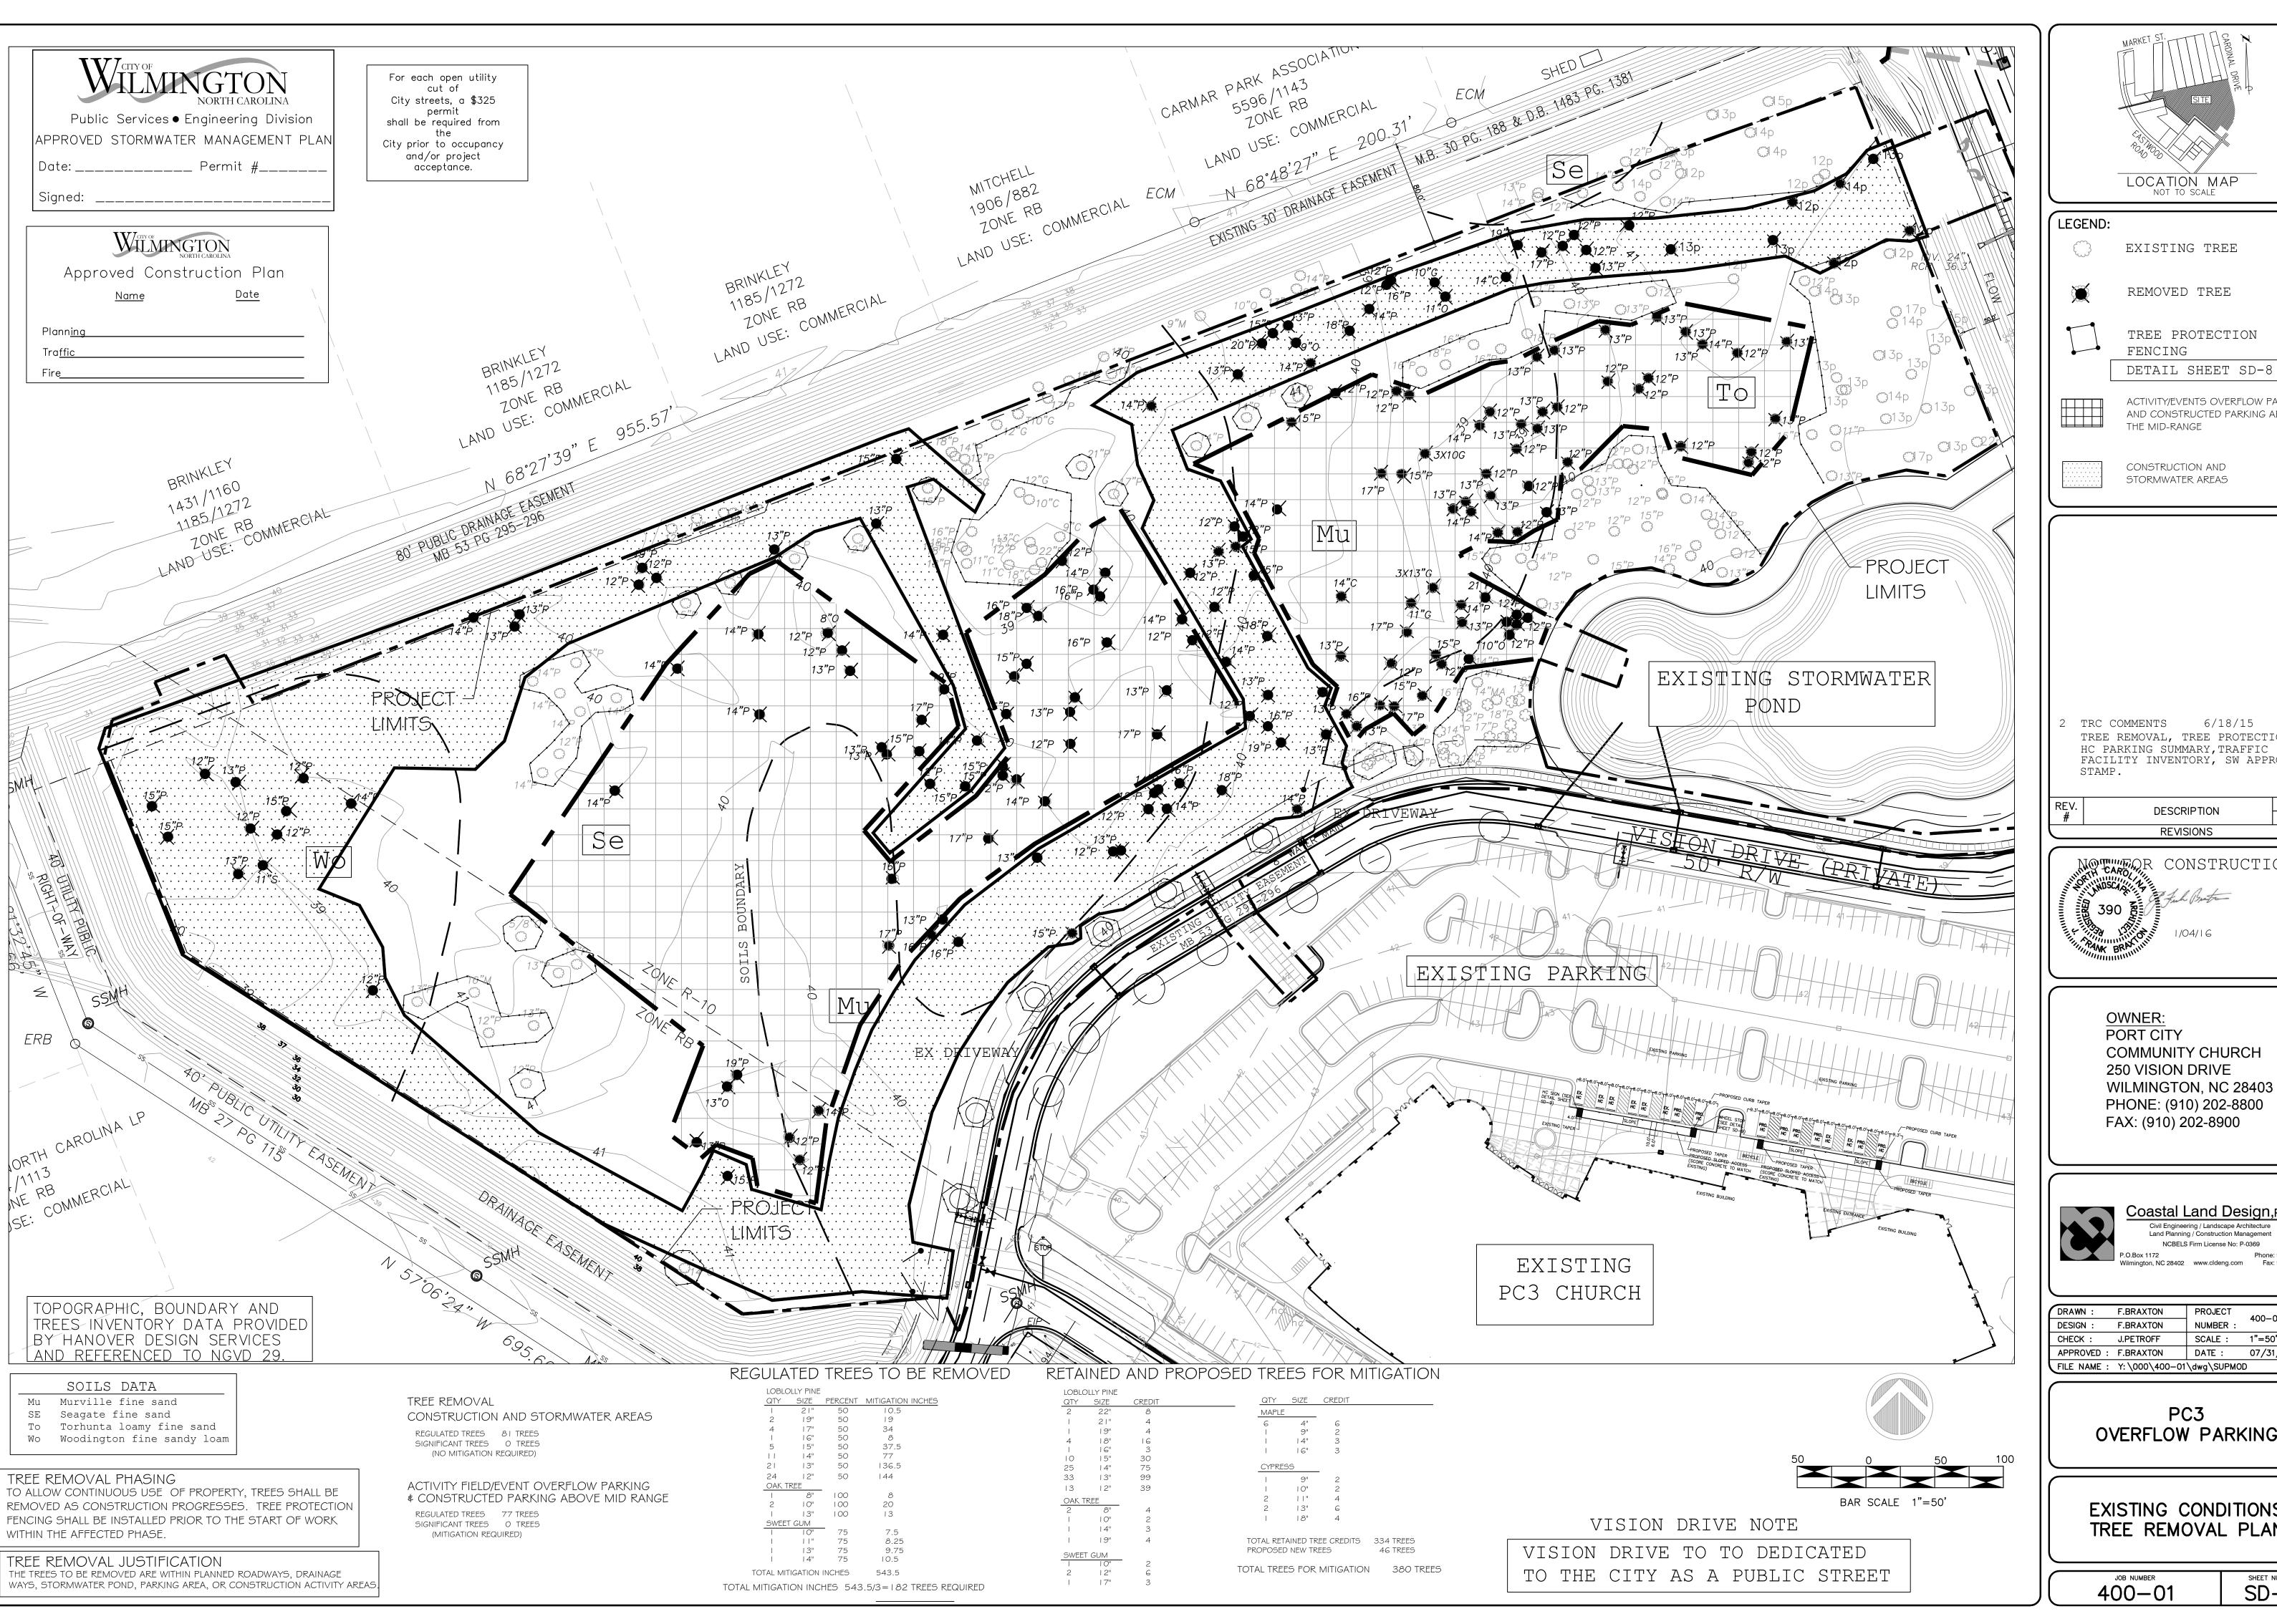

LOCATION MAP

EXISTING TREE REMOVED TREE

TREE PROTECTION FENCING

ACTIVITY/EVENTS OVERFLOW PARKING AND CONSTRUCTED PARKING ABOVE THE MID-RANGE


CONSTRUCTION AND STORMWATER AREAS

TRC COMMENTS 6/18/15 TREE REMOVAL, TREE PROTECTION, HC PARKING SUMMARY, TRAFFIC FACILITY INVENTORY, SW APPROVAL

REV.BY

DATE

DESCRIPTION REVISIONS

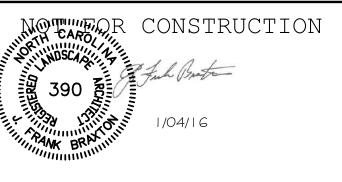

OWNER: PORT CITY COMMUNITY CHURCH 250 VISION DRIVE WILMINGTON, NC 28403 PHONE: (910) 202-8800 FAX: (910) 202-8900


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PC3 OVERFLOW PARKING


EXISTING CONDITIONS TREE REMOVAL PLAN

400-01 SD-2



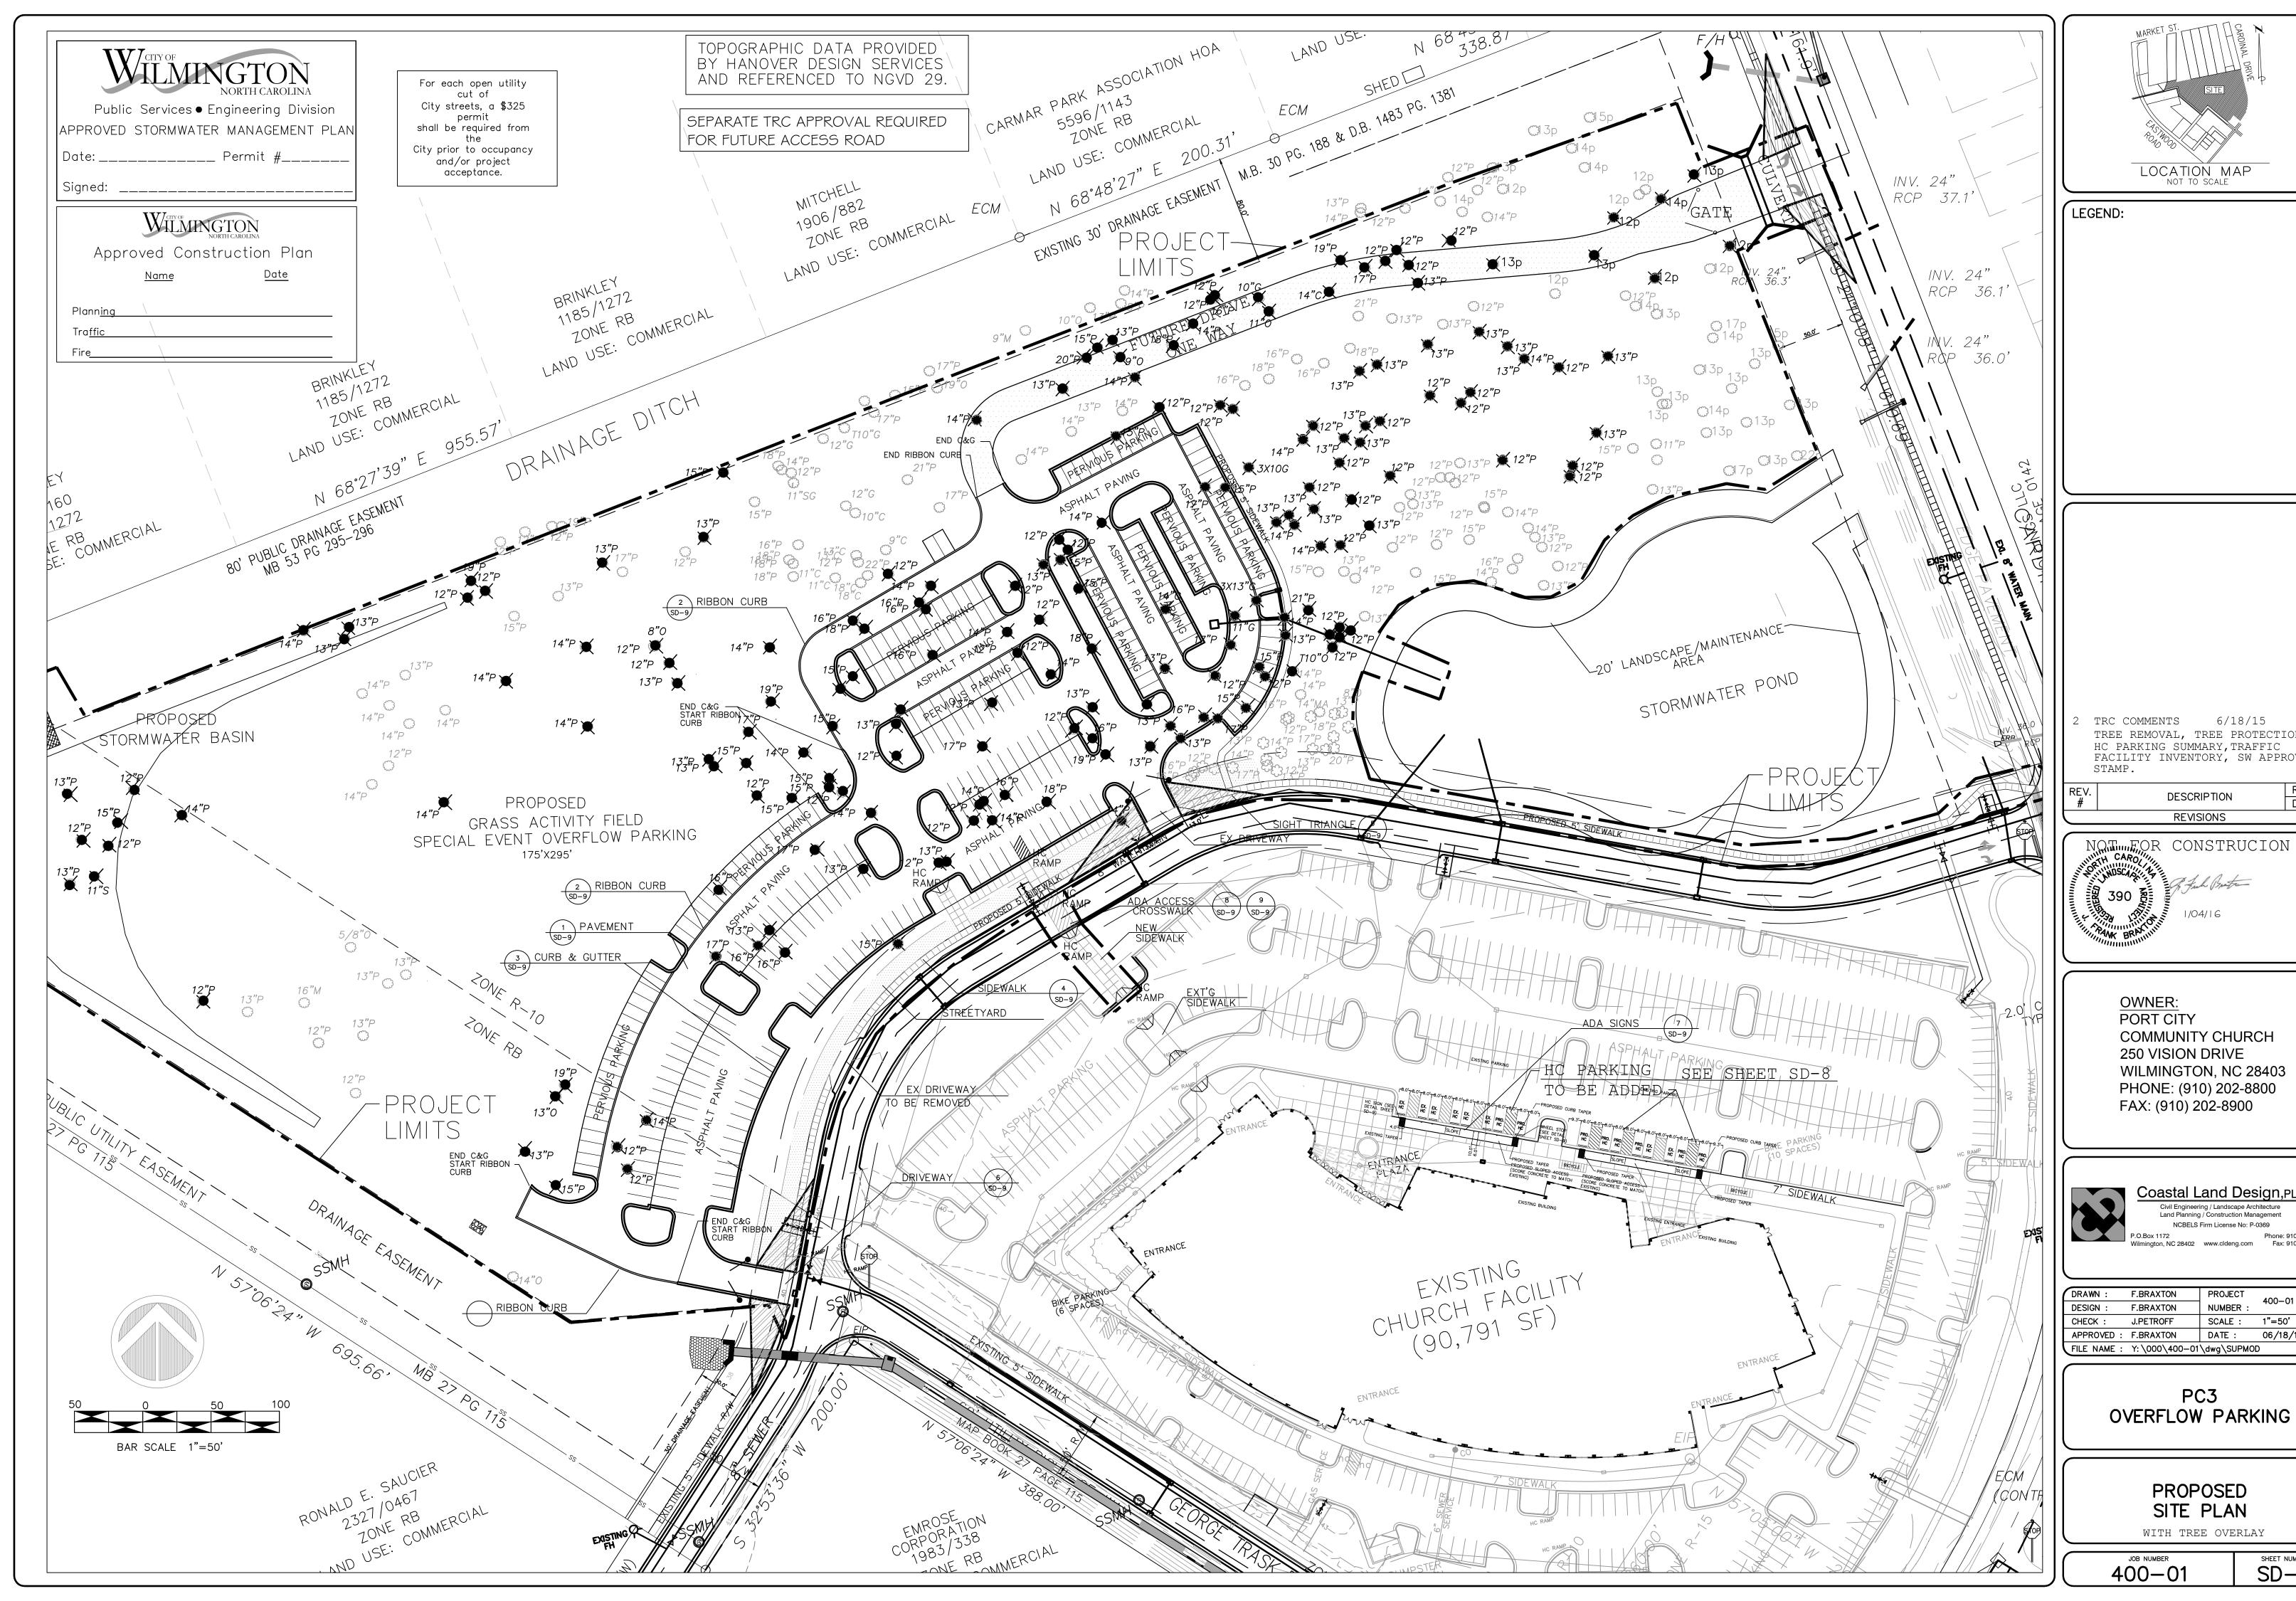

TREE REMOVAL, TREE PROTECTION,
HC PARKING SUMMARY, TRAFFIC
FACILITY INVENTORY, SW APPROVAL REV.BY DATE

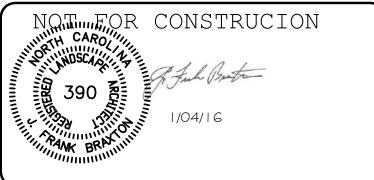


COMMUNITY CHURCH WILMINGTON, NC 28403 PHONE: (910) 202-8800 FAX: (910) 202-8900





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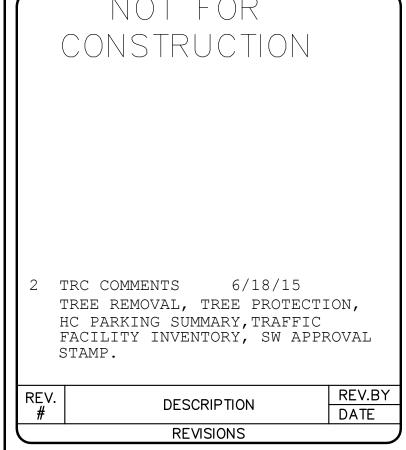
SITE PLAN


SHEET NUMBER



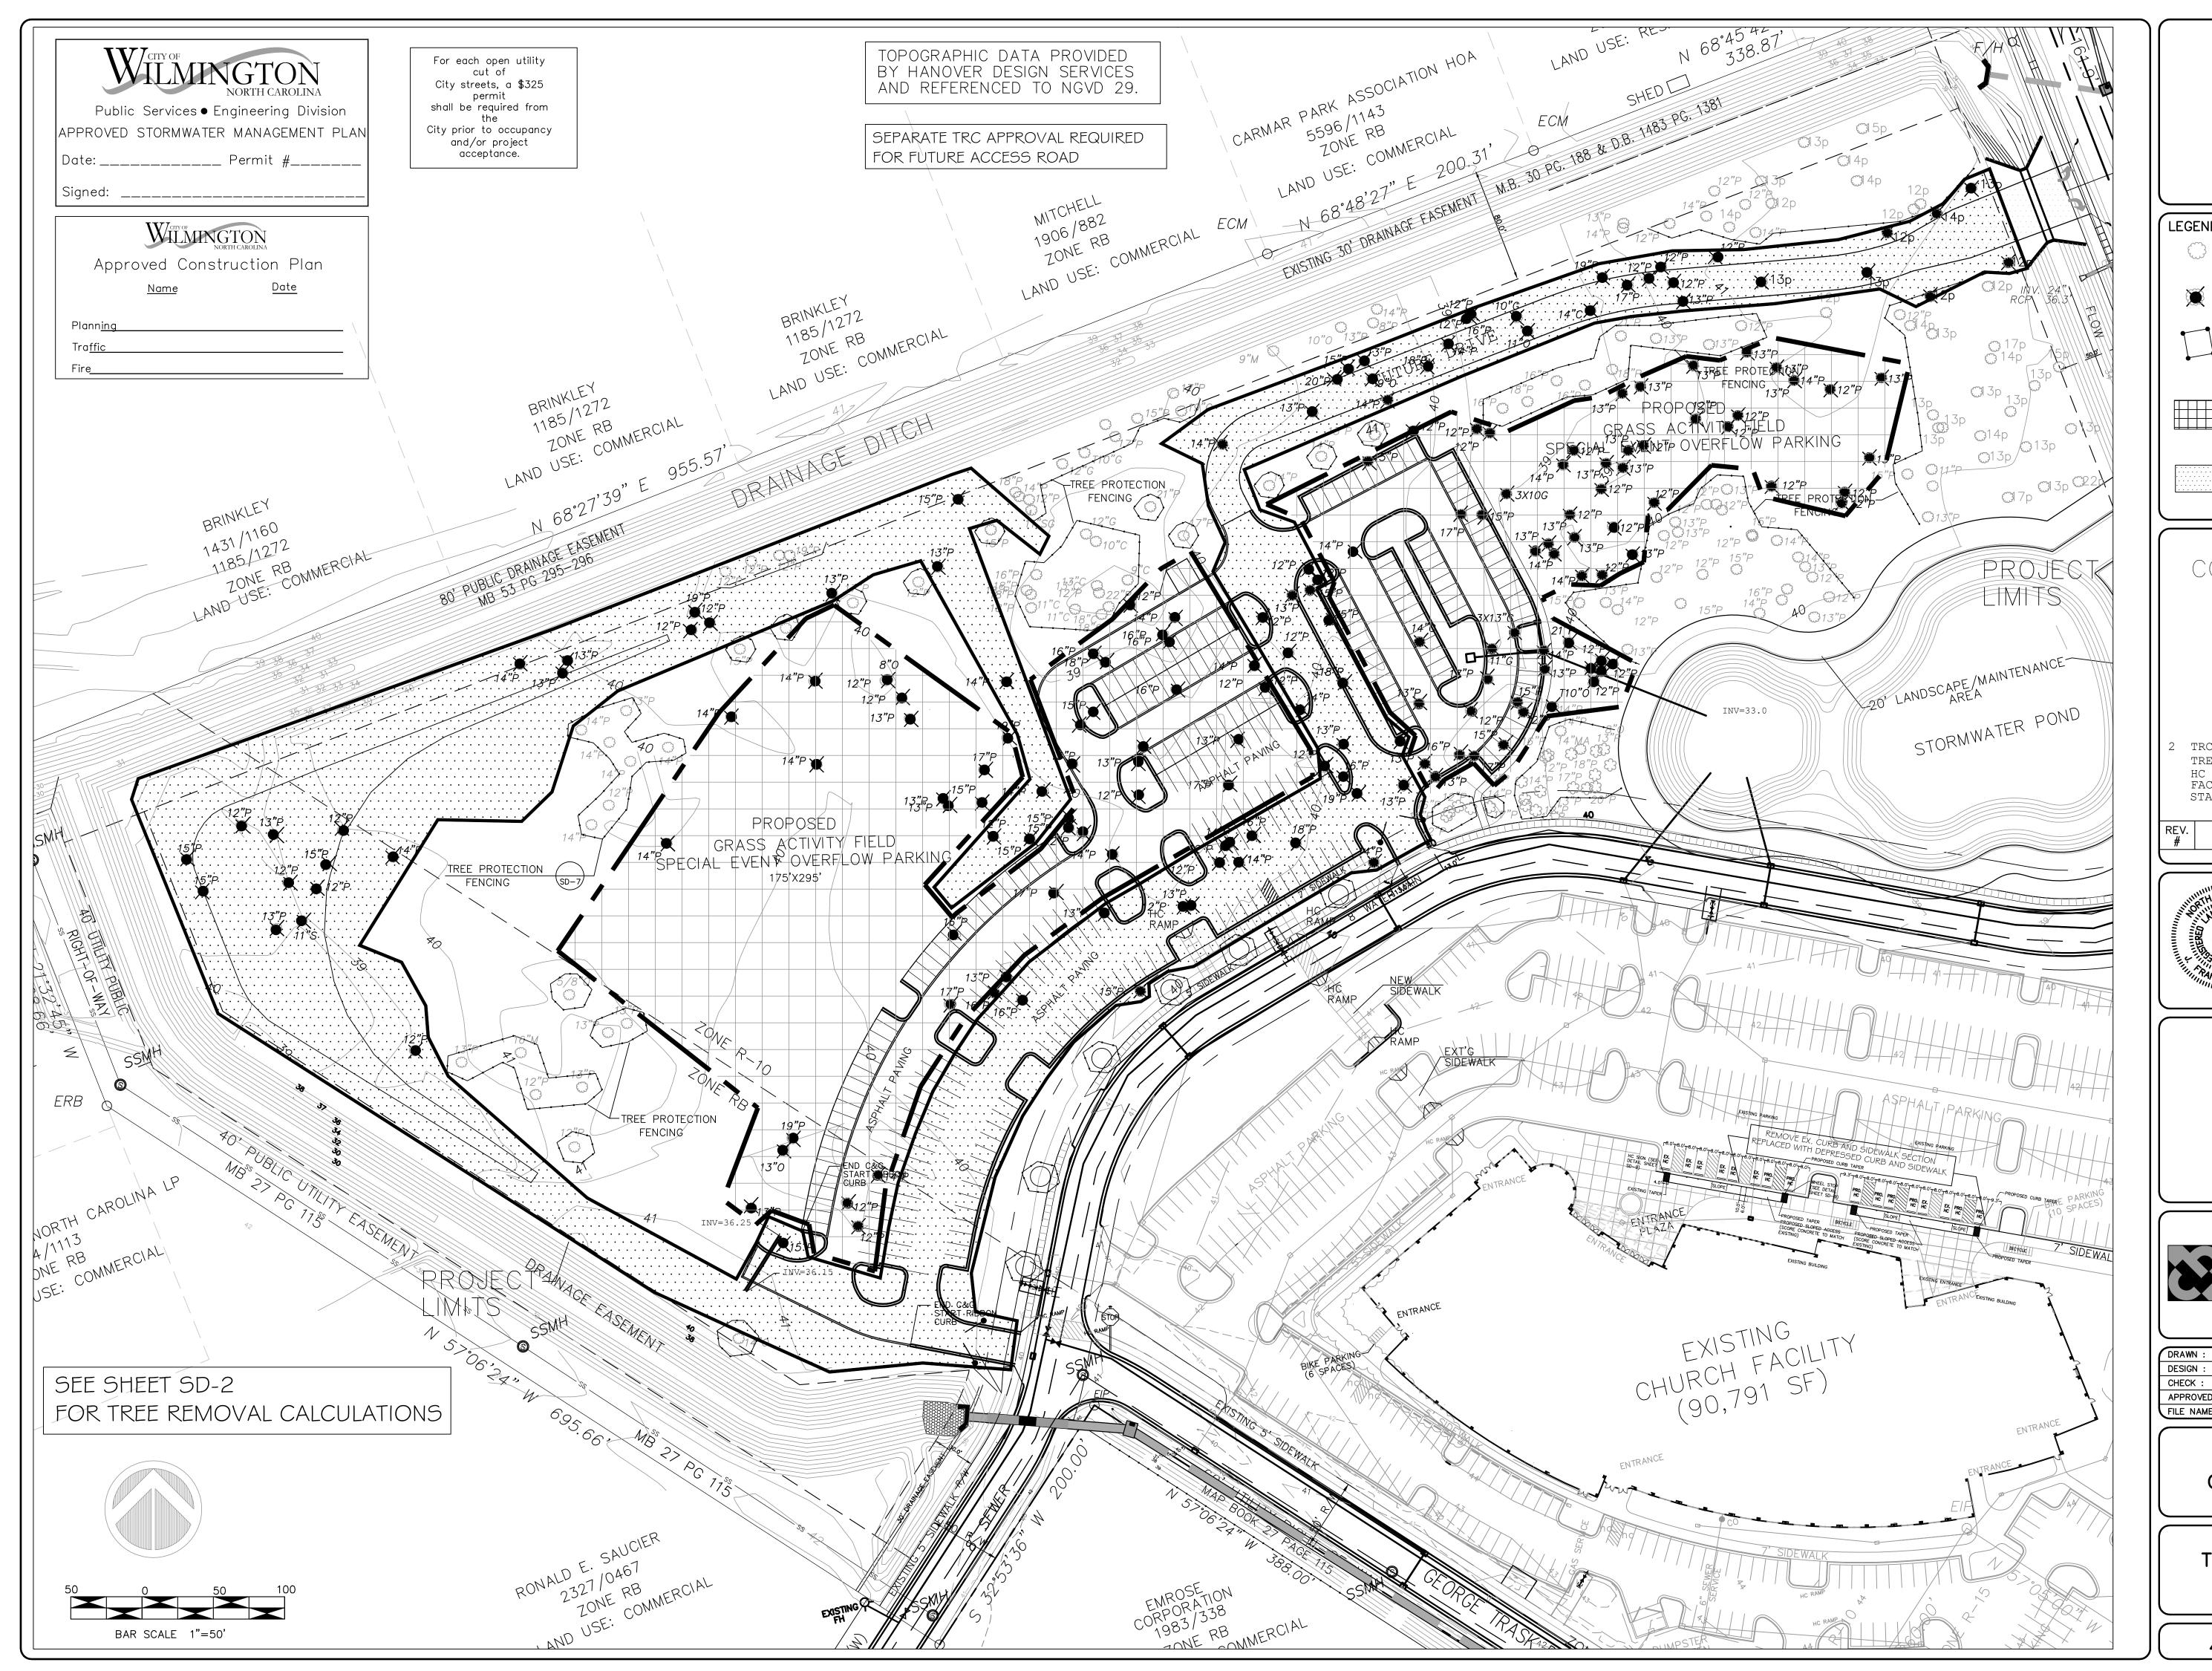

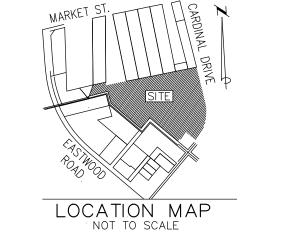

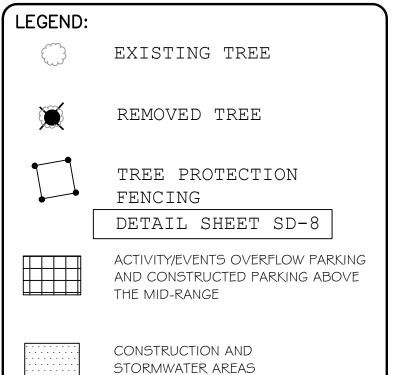

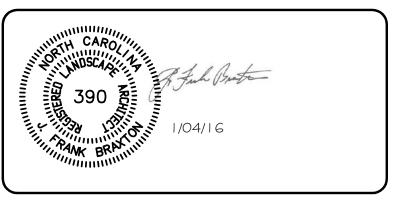

OWNER:
PORT CITY
COMMUNITY CHURCH
250 VISION DRIVE
WILMINGTON, NC 28403
PHONE: (910) 202-8800
FAX: (910) 202-8900





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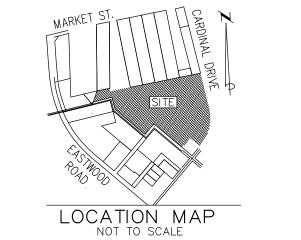
PC3 OVERFLOW PARKING


TREE REMOVAL PLAN


JOB NUMBER SHEET NUMBER SD-4



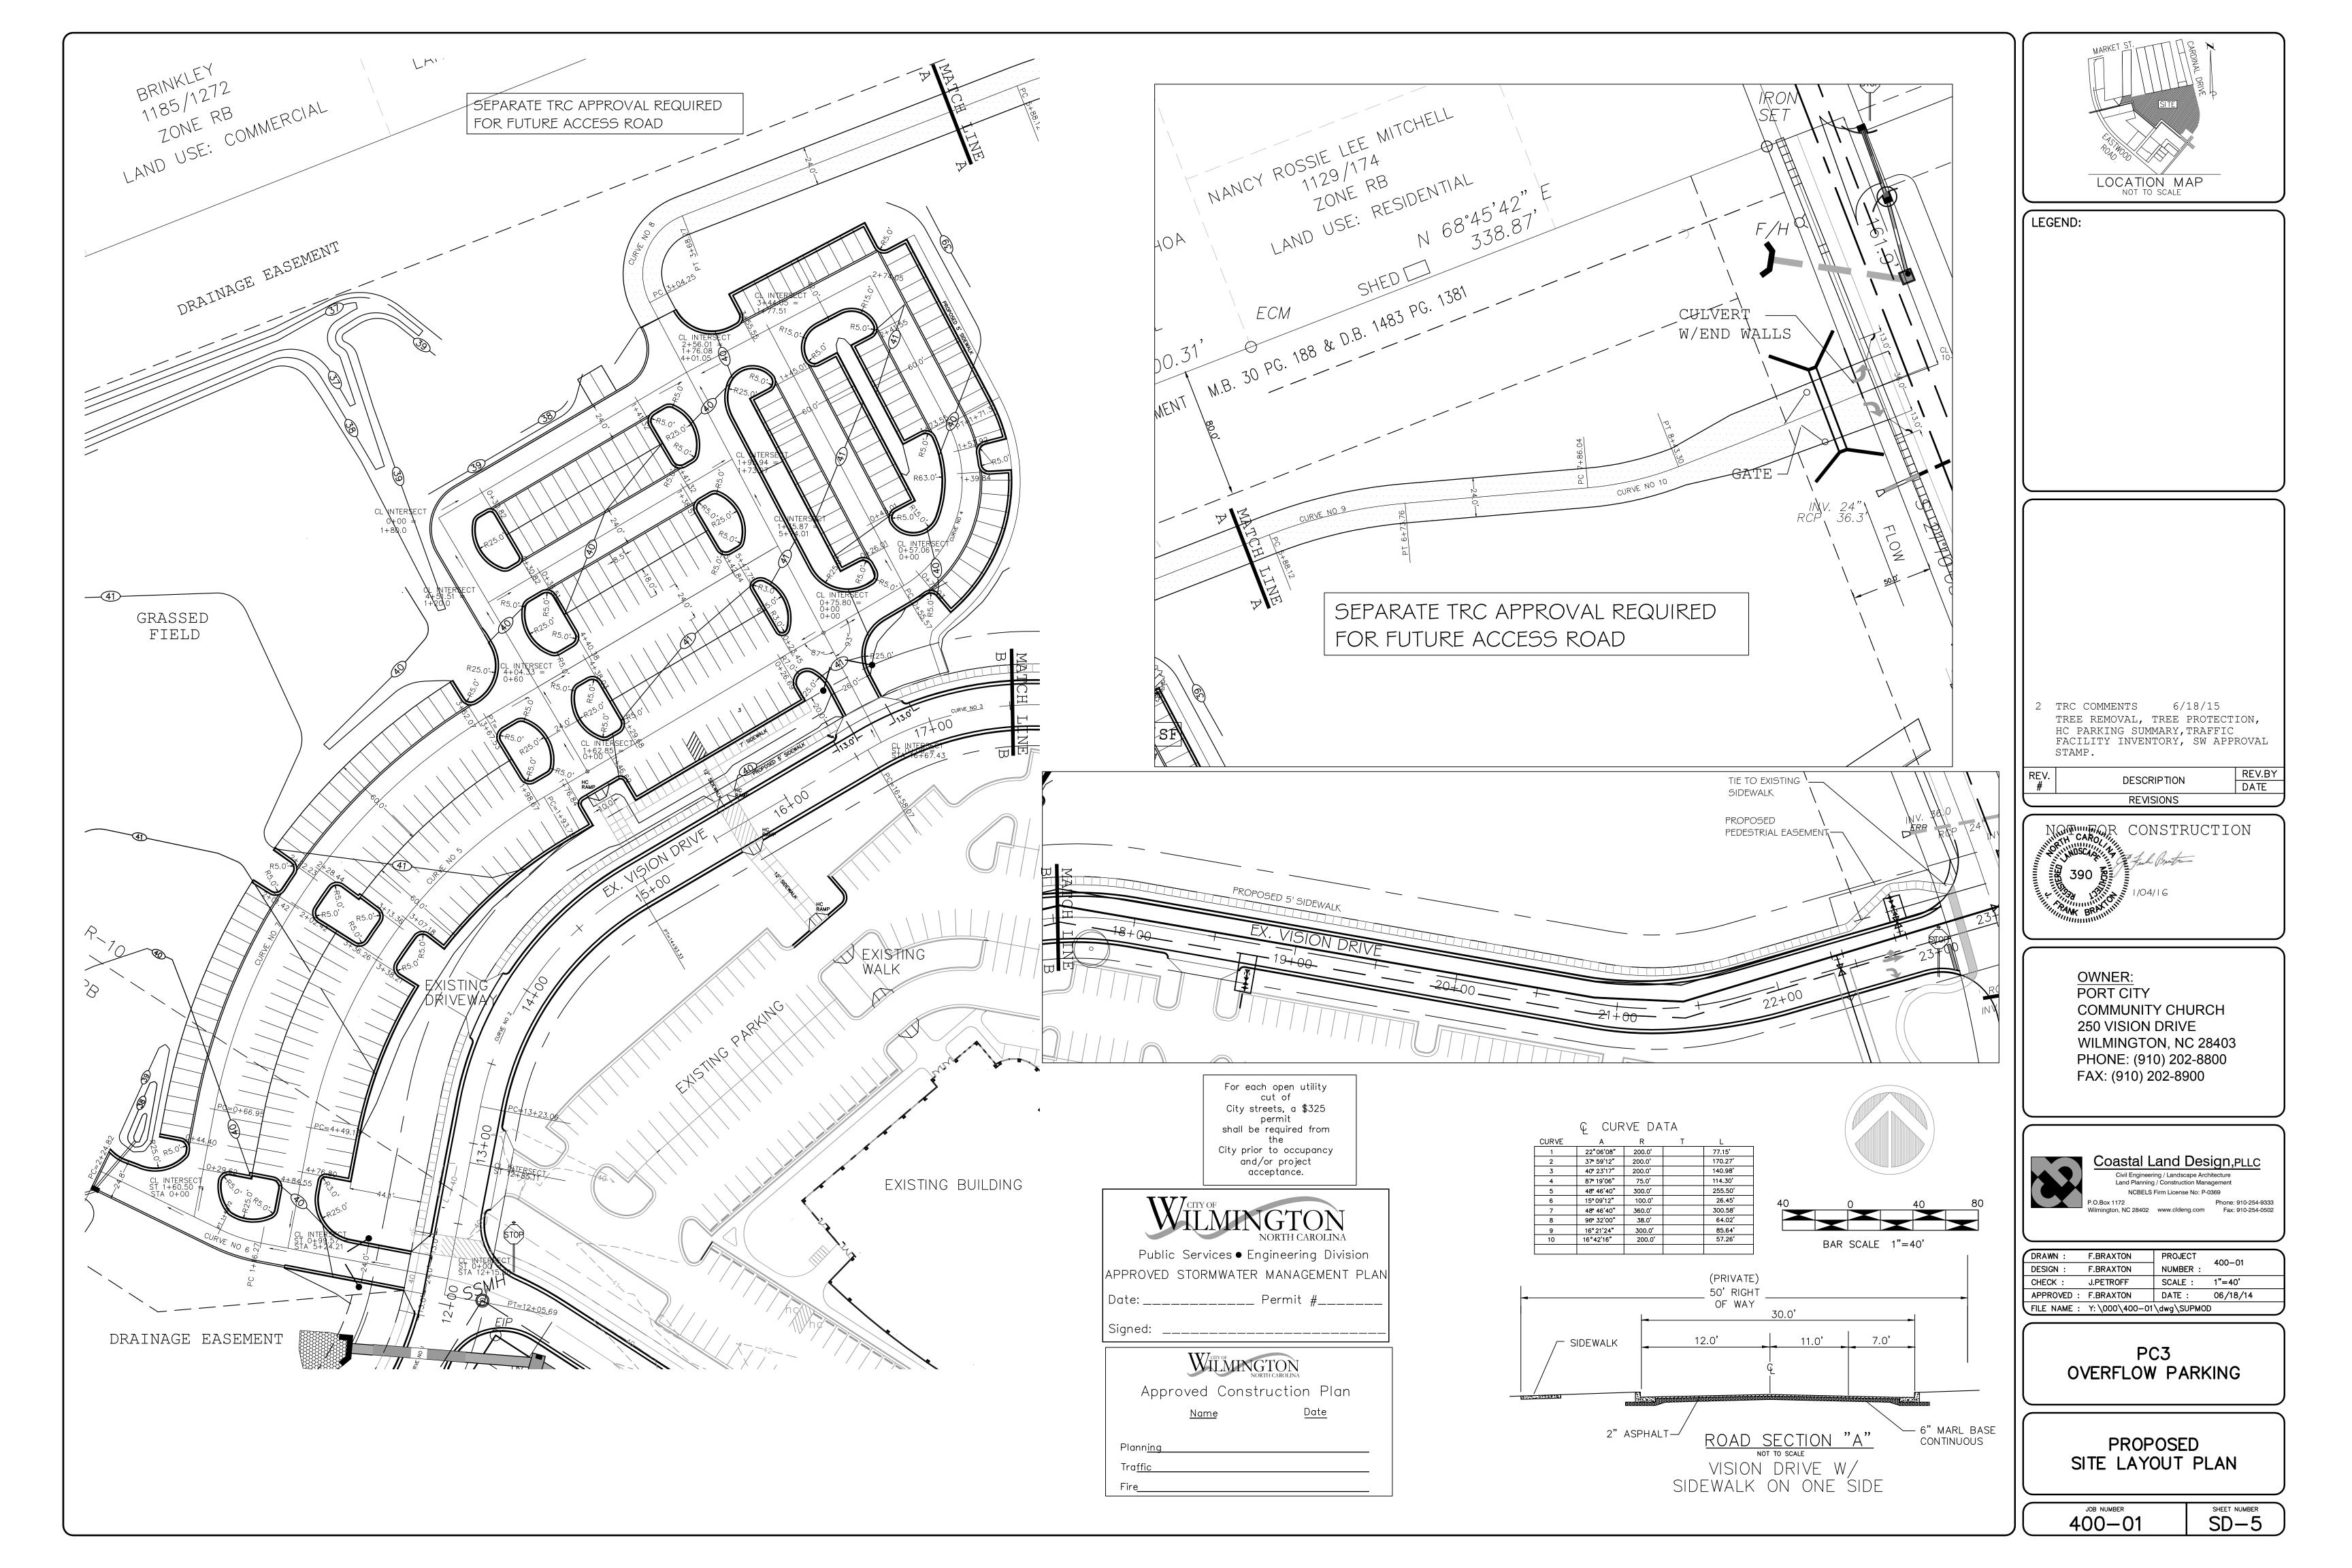

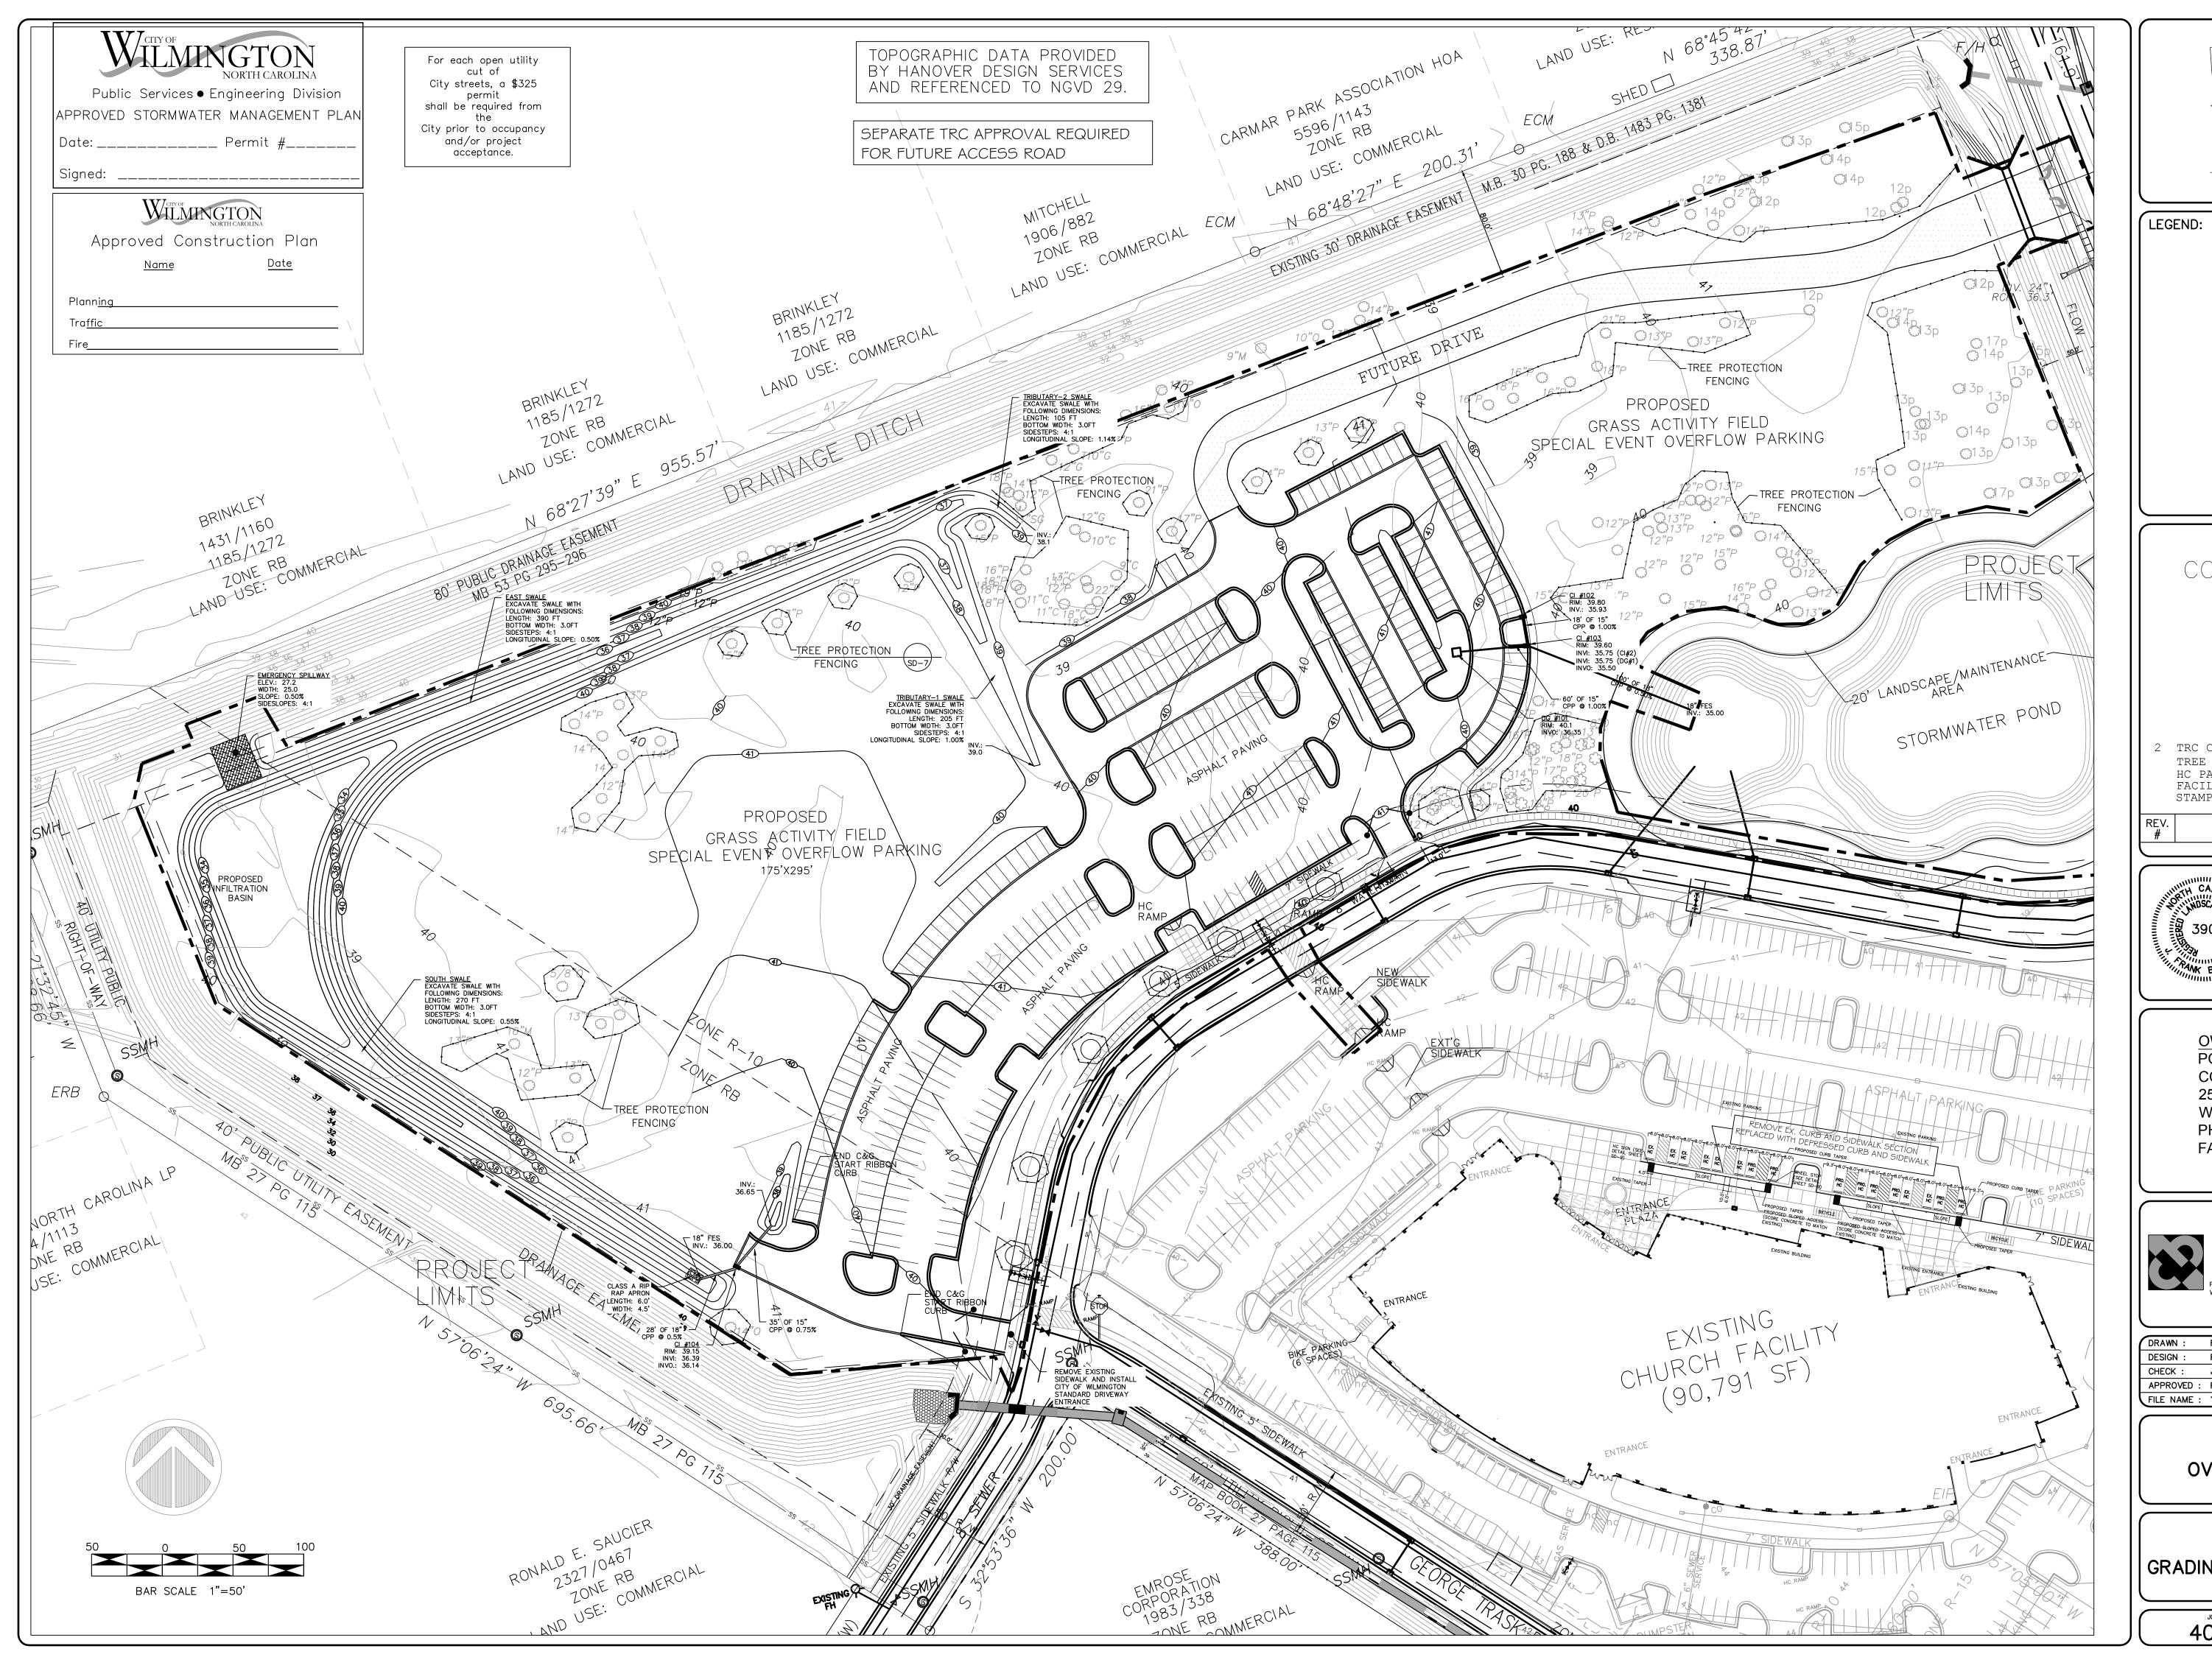


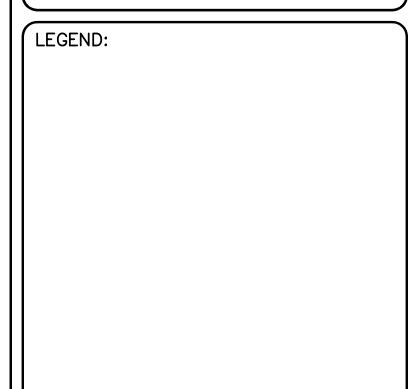

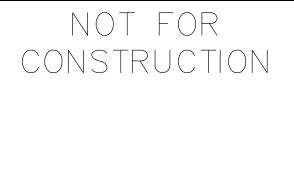

TRC COMMENTS 6/18/15
TREE REMOVAL, TREE PROTECTION,
HC PARKING SUMMARY, TRAFFIC
FACILITY INVENTORY, SW APPROVAL
STAMP.

M. DESCRIPTION
REV.BY
DATE

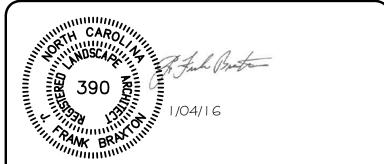

REVISIONS

OWNER:
PORT CITY
COMMUNITY CHURCH
250 VISION DRIVE
WILMINGTON, NC 28403
PHONE: (910) 202-8800
FAX: (910) 202-8900





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PC3 OVERFLOW PARKING

PROPOSED GRADING – DRAINAGE PLAN

JOB NUMBER SHEET NUMBER SD-6



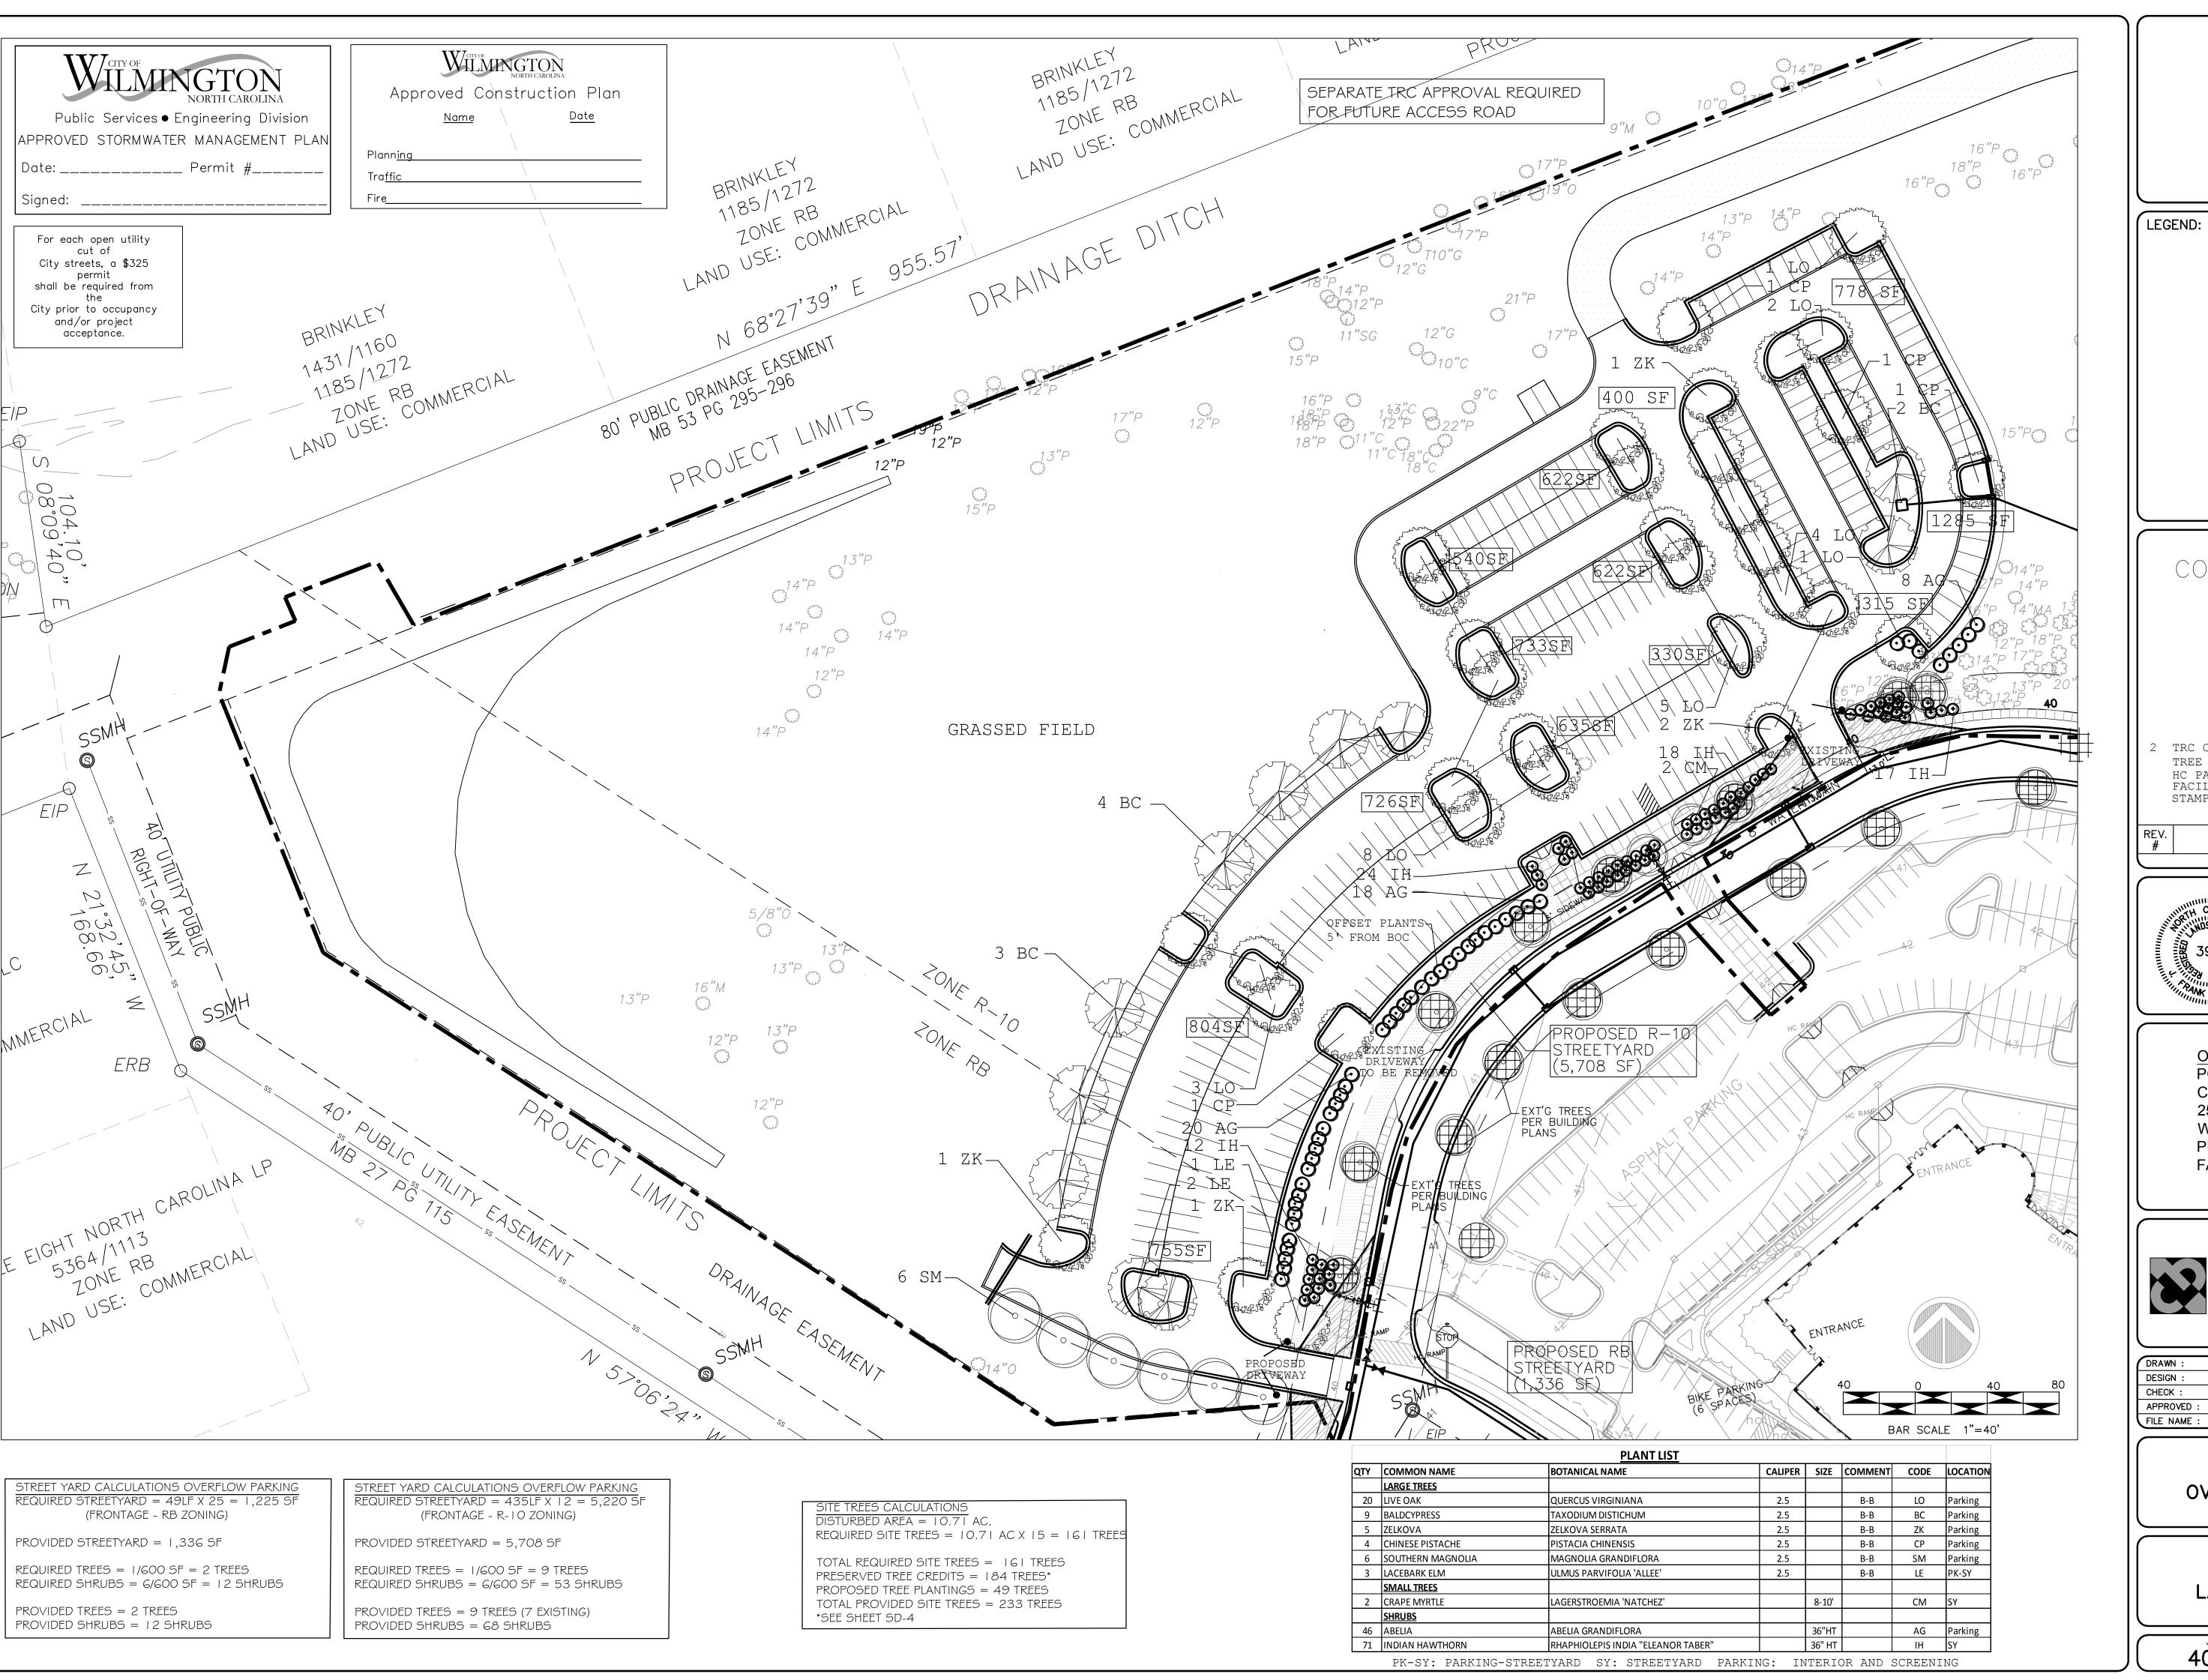

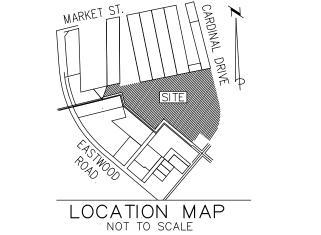CONSTRUCTION

2 TRC COMMENTS 6/18/15 TREE REMOVAL, TREE PROTECTION,
HC PARKING SUMMARY, TRAFFIC
FACILITY INVENTORY, SW APPROVAL

REV.BY

DESCRIPTION DATE REVISIONS



OWNER: PORT CITY COMMUNITY CHURCH 250 VISION DRIVE WILMINGTON, NC 28403 PHONE: (910) 202-8800 FAX: (910) 202-8900




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	APPROVED :	F.BRAXTON	DATE:	06/18/14
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OVERFLOW PARKING

PROPOSED LANDSCAPE PLAN

400-01 SD-7

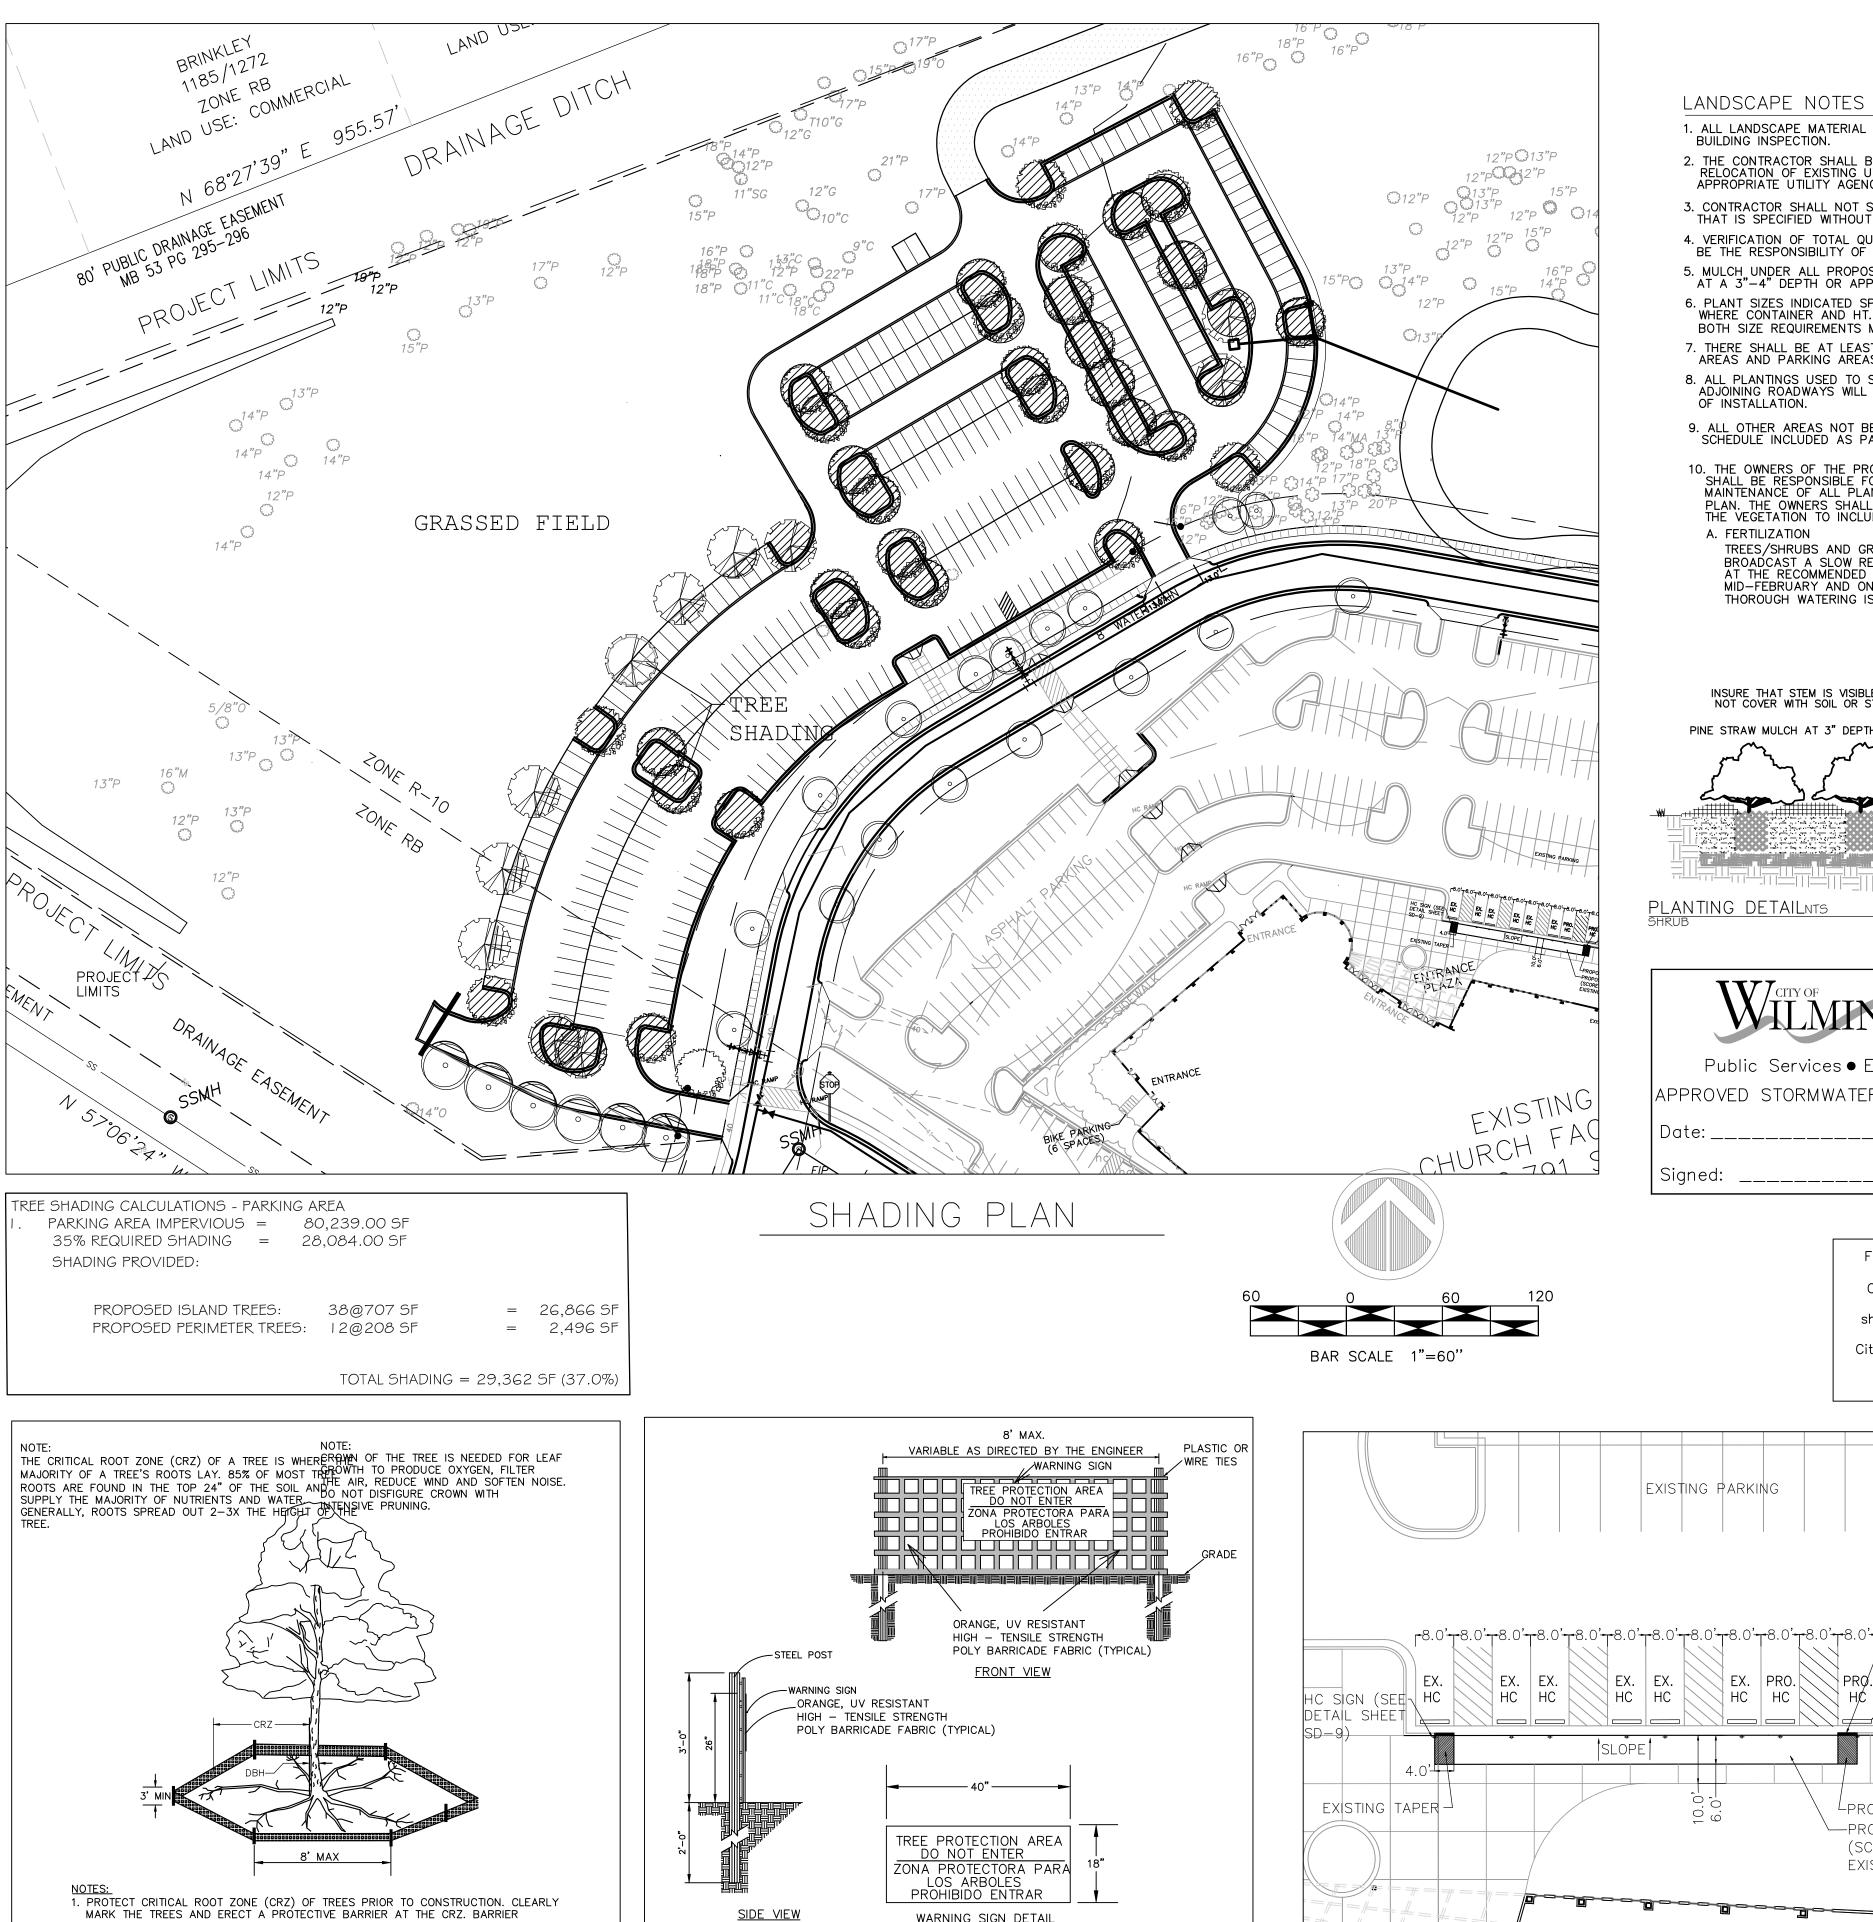

WARNING SIGN DETAIL

BE 3" HIGH, MINIMUM, CLEARLY LEGIBLE AND SPACED AS DETAILED.

4. ATTACH SIGNS SECURELY TO FENCE POSTS AND FABRIC. MAINTAIN TREE

PROTECTION FENCE AND SIGNS THROUGHOUT DURATION OF PROJECT.

THAN TWO SIGNS PER PROTECTION AREA.

CONSTRUCTION.

FIELD CONDITIONS.

3. SIGNS SHALL BE PLACED AT 50' MAXIMUM INTERVALS. PLACE A SIGN AT EACH

6. ADDITIONAL SIGNS MAY BE REQUIRED BY CITY OF WILMINGTON, BASED ON ACTUAL

PROTECTION AREAS LESS THAN 100' IN PERIMETER, PROVIDE NO LESS

END OF LINEAR TREE PROTECTION AND 50' ON CENTER THEREAFTER. FOR TREE

SHALL BE MAINTAINED UNTIL CONSTRUCTION IS COMPLETE.

CONSTRUCTION EQUIPMENT, OR ANYTHING ELSE IS PROHIBITED.

CONTRACTOR SHALL REPAIR DAMAGE TO TREES.

AS NECESSARY.

2. CRZ RADIUS IS 1 FT PER INCH OF TREE DIAMETER AT BREAST HEIGHT (DBH)

3. IF CONSTRUCTION OCCURS WITHIN THE CRZ, AT LEAST 12" OF MULCH AND/OR

PLACED WHERE MACHINERY MANEUVERS TO REDUCE SOIL COMPACTION IN THIS ZONE.

5. FOR ALL TREES, CUTTING OF LARGE STRUCTURAL ROOTS LOCATED NEAR THE BASE

6. FAILING TO INSTALL OR MAINTAIN PROTECTION MEASURES SHALL RESULT IN A STOP

WILL REQUIRE OWNER TO POST A LETTER OF CREDIT FOR 3 YRS FOR TREE MITIGATION.

OF THE TRUNK IS PROHIBITED. DO NOT COMPACT SOIL BENEATH TREES. NO

EQUIPMENT SHALL BE STORED BENEATH TREES. DAMAGING THE BARK WITH

VEHICLE SHALL BE ALLOWED TO PARKUNDER TREES. NO MATERIALS OR

4. WHERE SIDEWALKS AND PATHWAYS PASS WITHIN CRZ, EXTRA CARE SHALL BE TAKEN TO AVOID DAMAGE THE TREE PROTECTION FENCING SHALL NOT BE VIOLATED FOR THE ENTIRE

THE ROOTS. ALTERNATE CONSTRUCTION METHODS, SUCH AS A REINFORCED SIDEWALK, SHALL BE IMPLEMENTED URATION OF THE PROJECT WITHOUT APPROVAL FROM URBAN FORESTRY STAFF.

AS NECESSARY.

2. WARNING SIGNS TO BE MADE OF DURABLE, WEATHERPROOF MATERIAL. LETTERS TO

WORK ORDER AND FINE OF \$500/DAY. DISTURBANCE OTHER THAN THAT ALLOWED ON THE APPROVED PLANTREE PROTECTION FENCING AND SIGNAGE SHALL BE REMOVED AFTER

1. ALL LANDSCAPE MATERIAL MUST BE INSTALLED PRIOR TO FINAL BUILDING INSPECTION. 2. THE CONTRACTOR SHALL BE RESPONSIBLE FOR THE LOCATION AND/OR RELOCATION OF EXISTING UTILITIES IN COORDINATION WITH THE APPROPRIATE UTILITY AGENCY OR COMPANY. 3. CONTRACTOR SHALL NOT SUBSTITUTE FOR ANY OF THE PLANT MATERIAL THAT IS SPECIFIED WITHOUT PRIOR APPROVAL OF THE LANDSCAPE ARCHITECT 4. VERIFICATION OF TOTAL QUANTITIES AS SHOWN IN THE PLANT LIST SHALL BE THE RESPONSIBILITY OF THE CONTRACTOR. 5. MULCH UNDER ALL PROPOSED TREES AND SHRUBS WITH PINE NEEDLES AT A 3"-4" DEPTH OR APPROVED EQUAL. 6. PLANT SIZES INDICATED SPECIFY MINIMUM ALLOWABLE SIZES AT PLANTING. WHERE CONTAINER AND HT. SIZES ARE INDICATED FOR A SINGLE SPECIES, BOTH SIZE REQUIREMENTS MUST BE MET. 7. THERE SHALL BE AT LEAST A 3 FT. SEPARATION BETWEEN LANDSCAPED AREAS AND PARKING AREAS TO ALLOW VEHICLE OVERHANG. 8. ALL PLANTINGS USED TO SCREEN THE DRIVES AND PARKING AREAS FROM ADJOINING ROADWAYS WILL NEED TO BE A MINIMUM OF 24" HIGH AT TIME OF INSTALLATION. 9. ALL OTHER AREAS NOT BEING MULCHED TO BE SEEDED PER SEEDING SCHEDULE INCLUDED AS PART OF THE S&E PLANS.. 10. THE OWNERS OF THE PROPERTY AND THEIR AGENTS, HEIRS, OR ASSIGNS SHALL BE RESPONSIBLE FOR THE INSTALLATION, PRESERVATION AND MAINTENANCE OF ALL PLANTING AND PHYSICAL FEATURES SHOWN ON THIS PLAN. THE OWNERS SHALL BE RESPONSIBLE FOR ANNUAL MAINTENANCE OF THE VEGETATION TO INCLUDE BUT NOT BE LIMITED TO: A. FERTILIZATION TREES/SHRUBS AND GRASSED AREAS BROADCAST A SLOW RELEASE FERTILIZER OVER THE MULCHED BEDS AT THE RECOMMENDED RATES AS SHOWN ON THE BAGS, ONCE MID-FEBRUARY AND ONCE MID-SEPTEMBER. THOROUGH WATERING IS REQUIRED UPON COMPLETION.

> INSURE THAT STEM IS VISIBLE -DO NOT COVER WITH SOIL OR STRAW.-ROOT BALL PINE STRAW MULCH AT 3" DEPTH. -NATIVE SOIL OR APPROVED IMPORTED BACKFILL. -DISTURBED NATIVE SOIL WW EXISTING GRADE UNDISTURBED EARTH

Public Services • Engineering Division APPROVED STORMWATER MANAGEMENT PLAN Permit # Signed:

For each open utility cut of City streets, a \$325 permit shall be required from the City prior to occupancy and/or project acceptance.

B. PRUNING WITHIN LIMITS

PRUNING WHEN NECESSARY, WILL BE DONE TO MAINTAIN THEIR NORMAL GROWTH PATTERN AND TO REMOVE DEAD OR DISEASED PLANT MATERIAL. THERE SHALL BE NO TOPPING OF TREES.

C. PEST CONTROL (OPTIONAL)

WEED CONTROL TO BE PROVIDED EARY FEBRUARY, APRIL, JUNE, AUGUST AND OCTOBER IN THE SHRUB/TREE BEDS AND IN THE LAWN AREAS. INSECT DAMAGE SHALLD BE TREATED WHEN NECESSARY TO PREVENT DAMAGE TO VEGETATION.

D. MULCHING ALL AREAS AROUND THE BUILDING FOUNDATION AND SHRUB/TREE BEDS SHALL BE RE-MULCHED SO THAT THEY CONTAIN A MIN. DEPTH OF TWO INCHES AND A MAXIMUM DEPTH OF THREE INCHES. MULCH USED SHALL EQUAL WHICH WAS SUPPLIED DURING THE INSTALLATION OF THE PLANTS.

MOWING SHALL BE DONE AS NECESSARY TO KEEP GRASS AT THE APPROPRIATE HEIGHT TO INSURE A HEALTHY GROWTH PATTERN

F. PROTECTION OF ROOT ZONES


TREE/SHRUB ROOT ZONES SHOULD BE PROTECTED FROM FUTURE CONSTRUCTION AND EQUIPMENT AS MUCH AS POSSIBLE TO AVOID DAMAGE OR COMPACTION TO THE ROOT AREAS.

G. WATERING SCHEDULE FOR IRRIGATION SYSTEM

MAINTENANCE SHALL INCLUDE A THOROUGH INITIAL WATERING WITH WEEKLY WATERINGS THEREAFTER FOR THE FIRST 30 DAYS. WATERINGS THEREAFTER BE ON AN AS NEEDED SCHEDULE PER LOCAL CONDITIONS.

H. STAKE AND WIRE REMOVAL

AT THE END OF THE FIRST YEAR ALL PLANT STAKING AND GUYING SYSTEMS SHALL BE REMOVED.

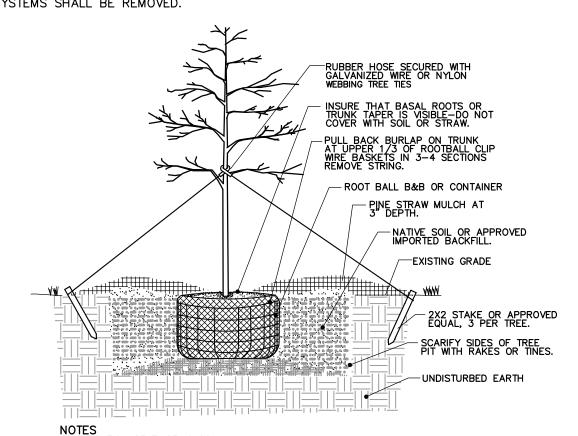

SCARFICATION OF EXISTING SOIL

3', RADIUS MIN. FOR TREES 2" CAL OR GREATER.

3', RADIUS MIN. FOR TREES LESS THAN 2" CAL

3', RADIUS MIN. FOR TREES LESS THAN 2" CAL

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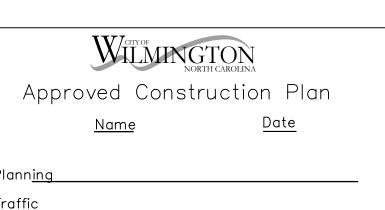
4', CAL


4', CAL

5', C FOR TREES PLANTED ON SLOPES LESS THAN 3:1, TAPEROIL AROUND TREE 1.5x WIDTH OF TREE BALL. FOR TREES PLANTED ON SLOPES GREATER THAN 3:1 THE SOIL AROUND THE TREE SHOULD NOT EXCEED 2:1.

PLANTING DETAIL

LARGE TREE-2.5" CALIPER OR LARGER



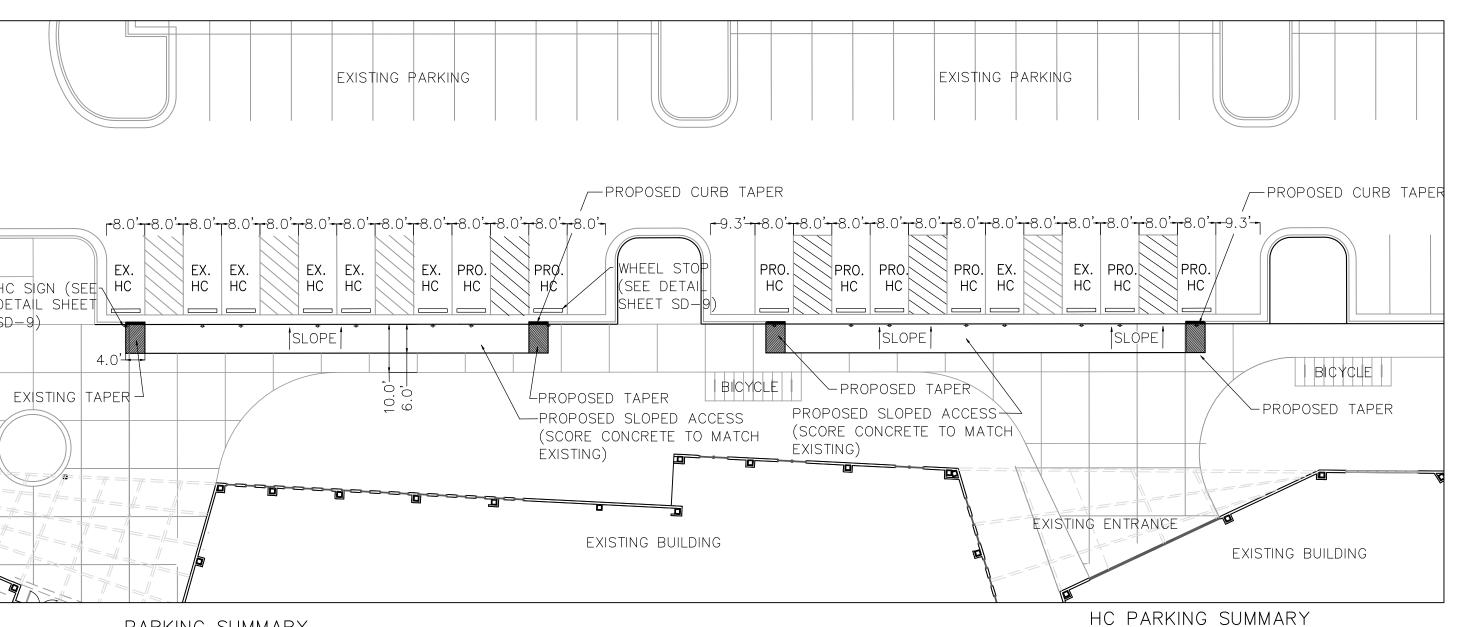

PARKING SUMMARY

EXISTING NUMBER OF SPACES = 586 SPACES PROPOSED SPACES = 291 SPACES TOTAL NUMBER OF SPACES = 877 SPACES


TOTAL NUMBER OF HC SPACES = 20 SPACES (REQUIRED=18 SPACES)


PROPOSED ADDITIONAL HANDICAPPED PARKING 1:20

REQUIRED ADDITIONAL HC SPACES = 6 SPACES PROPOSED HC SPACES = 20 SPACES

Overflow HC Spaces are being located at the Building Entrances per ADA Code.


EXISTING NUMBER OF HC SPACES = 12 SPACES

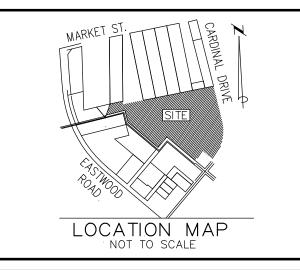

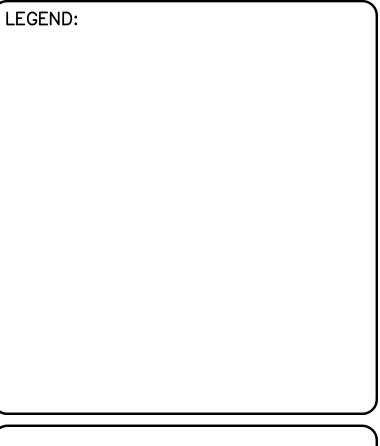

TRC COMMENTS 6/18/15 TREE REMOVAL, TREE PROTECTION, HC PARKING SUMMARY, TRAFFIC FACILITY INVENTORY, SW APPROVAL

REV.BY **DESCRIPTION** DATE REVISIONS

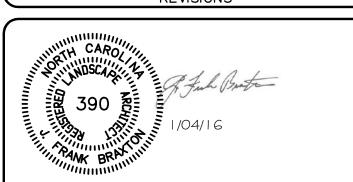

OWNER: PORT CITY **COMMUNITY CHURCH** 250 VISION DRIVE WILMINGTON, NC 28403 PHONE: (910) 202-8800 FAX: (910) 202-8900




Coastal Land Design, PLLC Civil Engineering / Landscape Architecture Land Planning / Construction Management NCBELS Firm License No: P-0369 lmington, NC 28402 www.cldeng.com Fax: 910-254-0502

DRAWN:	F.BRAXTON	PROJECT	400-01
DESIGN :	F.BRAXTON	NUMBER :	400-01
CHECK :	J.PETROFF	SCALE :	VARIES
APPROVED :	F.BRAXTON	DATE:	06/18/14
FILE NAME :	Y: \000\400-01	\dwg\SUPMO[

OVERFLOW PARKING

LANDSCAPE DETAILS SHADING PLAN

SD-8

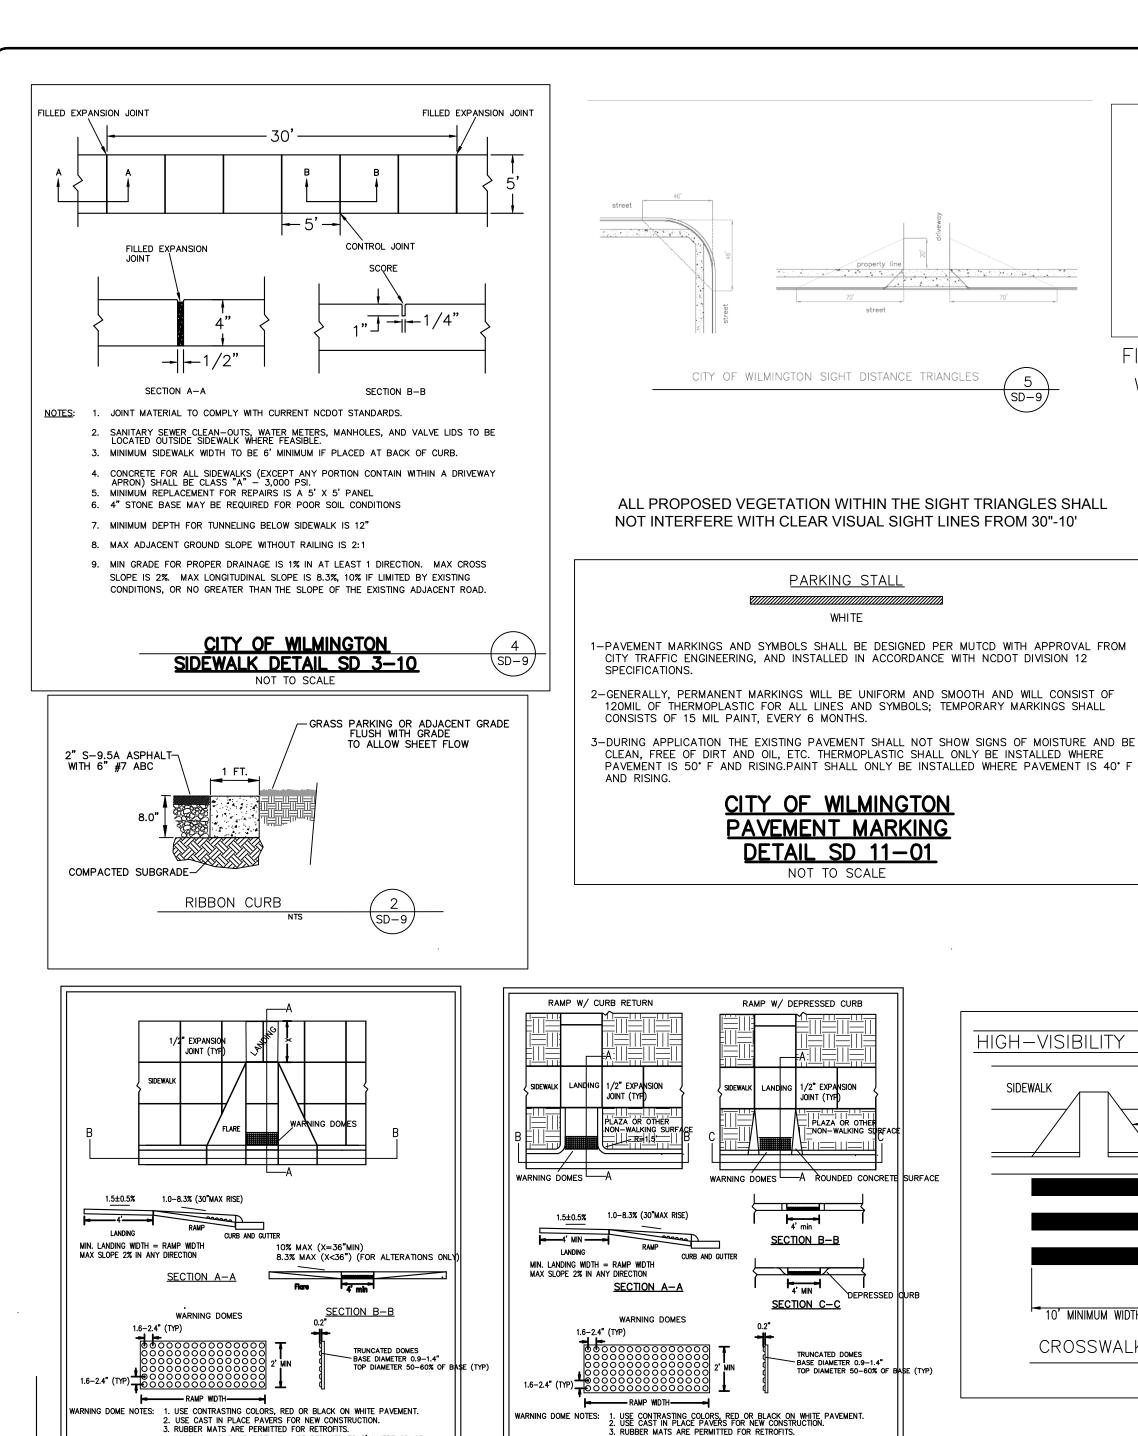

PERPENDICULAR CURB

SURFACE

TYPICAL LOCATION OF WHEELCHAIR RAMP

OF WARNING 6' 6' GRASS STRIP

PLAN VIEW WHEELCHAIR RAMP

GUIDELINES FOR WHEELCHAIR RAMPS & DEPRESSED CURBS

GUIDELINES FOR

WHEELCHAIR RAMPS &

DEPRESSED CURBS

SHEET 1 OF 2

SD 8-10

VERTICAL BREAK
IN CURB
10' MIN.
PED-X-ING
SLOPE NOT TO EXCEED 12-1
ON RAMP AND FLARED SIDES

1/2" EXPANSION JOINT

SD 8-10


CALE NOT TO SCALE

DRAWN: PB/JSR

SCALE NOT TO SCALE

SCALE NOT TO SCALE

SEE OBSTRUCTION DETAIL

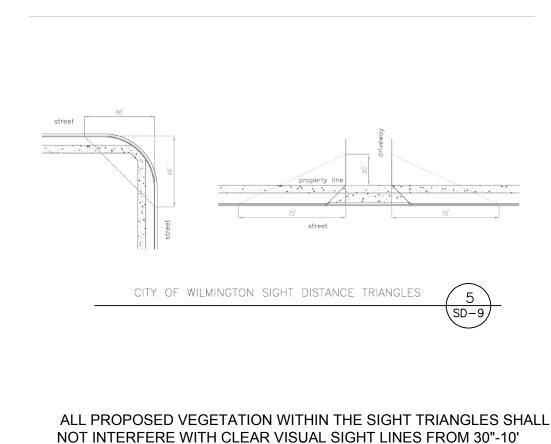

PARKING STALL


WHITE

PAVEMENT IS 50° F AND RISING.PAINT SHALL ONLY BE INSTALLED WHERE PAVEMENT IS 40° F


CITY OF WILMINGTON PAVEMENT MARKING DETAIL SD 11-01

NOT TO SCALE

CONSISTS OF 15 MIL PAINT, EVERY 6 MONTHS.

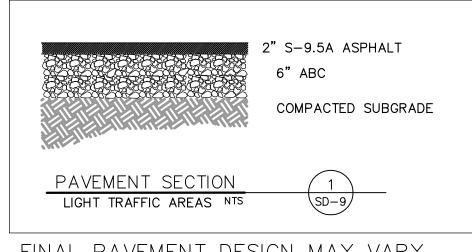



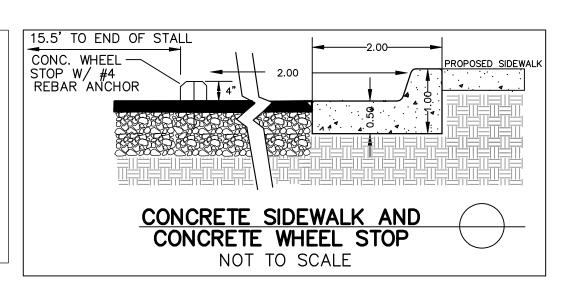

OBLIQUE VIEW

AGGREGATE BASE COURSE

VERTICAL CURB AND GUTTER

AGGREGATE BASE COURSE

VALLEY CURB

3. MINIMUM INSTALLATION LENGTH IS 5 FT. 4. CONCRETE TO BE 3000 PSI MIN

CONCRETE CURB & GUTTER

NOTES: 1. EXPANSION JOINT MATERIAL TO COMPLY WITH CURRENT NCDOT STANDARDS

2. 50' MAX EXPANSION JOINT SPACING, 10' MAX CONTRACTION JOINT SPACING

5. VERTICAL CURB AND GUTTER BASE CAN BE SLOPED 3/4" OR USE A FLAT BASE

Z AGGREGATE BASE COURSE

MEDIAN VERTICAL CURB AND GUTTER

VERTICAL CURB AND GUTTER

1/2" FILLED EXPANSION JOINT

AGGREGATE BASE COURSE

VERTICAL CURB

HEADER CURB


SLOPE CURB


GRANITE CURB


-AGGREGATE BASE COURSE


CONTRACTION JOINT


(1/4" X 1" DEEP SCORE)

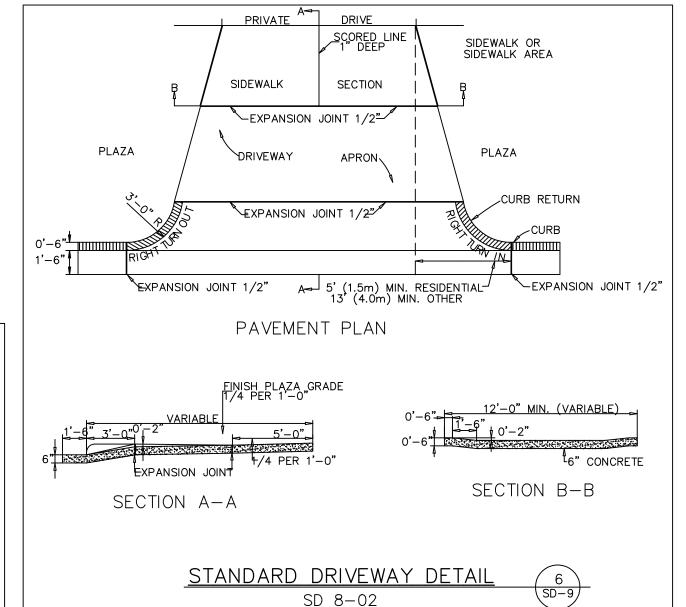

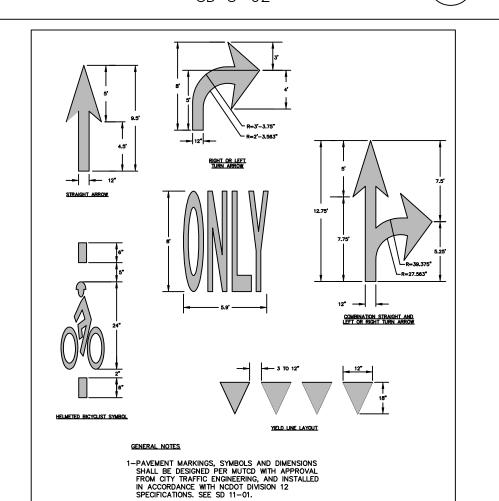

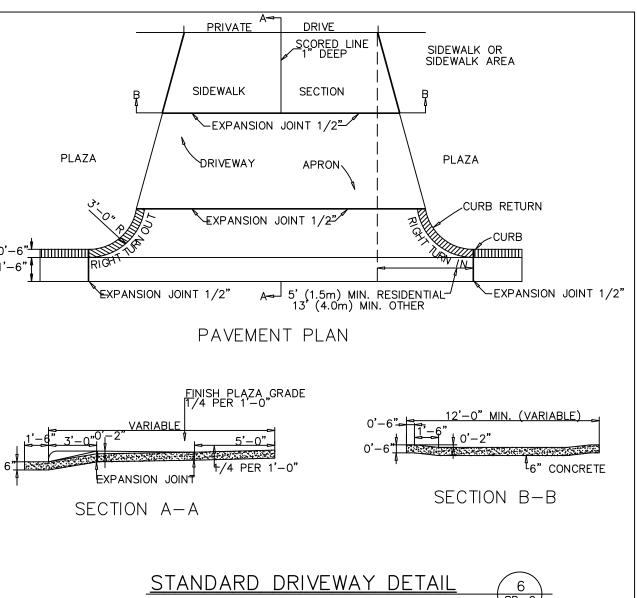

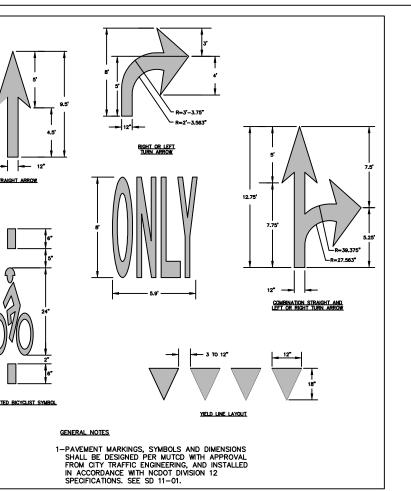

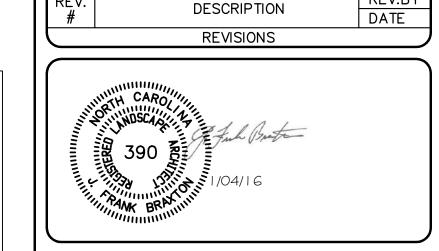

TRC COMMENTS 6/18/15

STAMP.

TREE REMOVAL, TREE PROTECTION, HC PARKING SUMMARY, TRAFFIC

FACILITY INVENTORY, SW APPROVAL

REV.BY

LOCATION MAP

LEGEND:

OWNER: PORT CITY COMMUNITY CHURCH 250 VISION DRIVE WILMINGTON, NC 28403 PHONE: (910) 202-8800 FAX: (910) 202-8900




Coastal Land Design,PLLC Civil Engineering / Landscape Architecture Land Planning / Construction Management NCBELS Firm License No: P-0369 Phone: 910-254-9333 /ilmington, NC 28402 www.cldeng.com Fax: 910-254-0502


1	DRAWN:	F.BRAXTON	PROJECT	400-01
	DESIGN :	F.BRAXTON	NUMBER :	400-01
	CHECK :	J.PETROFF	SCALE :	VARIES
	APPROVED :	F.BRAXTON	DATE :	06/18/14
	FILE NAME :	Y: \000\400-01	\dwg\SUPMOD	


OVERFLOW PARKING


PROPOSED SITE DETAILS


SD-9

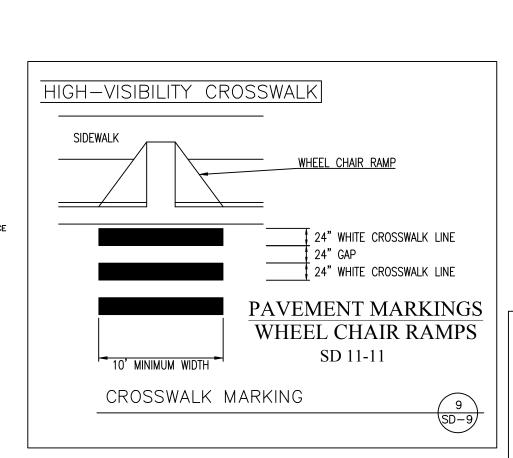


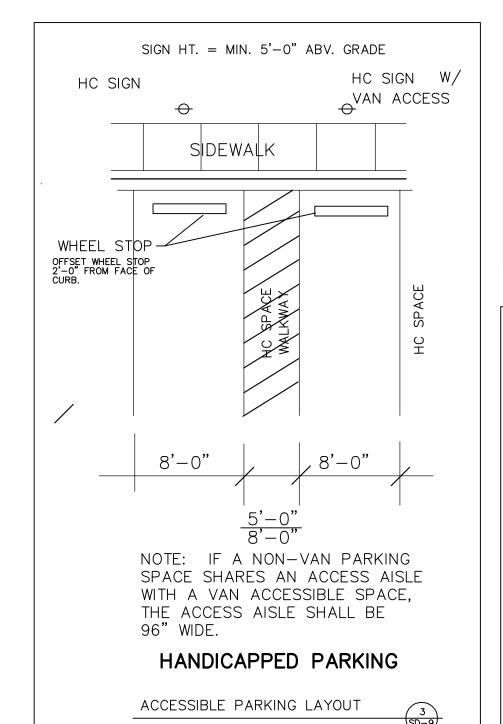

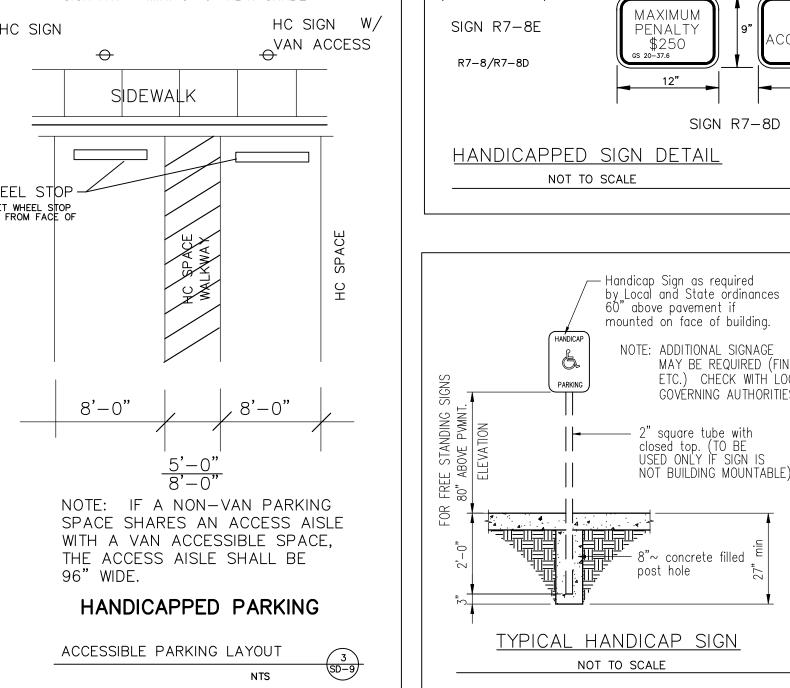

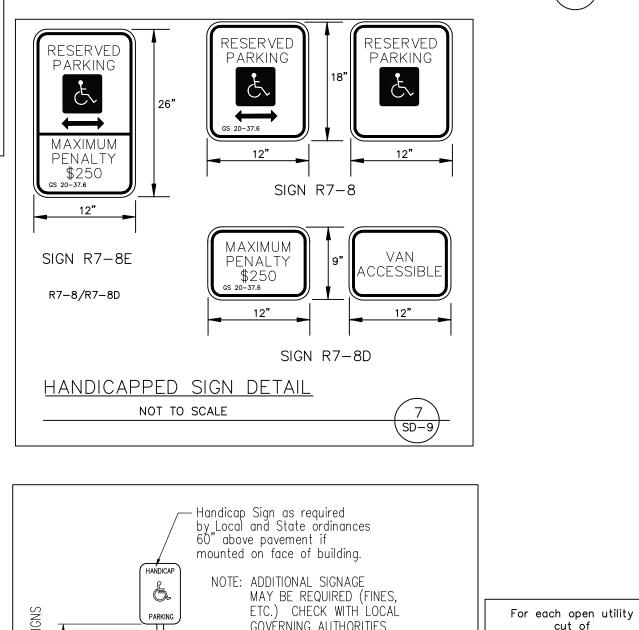

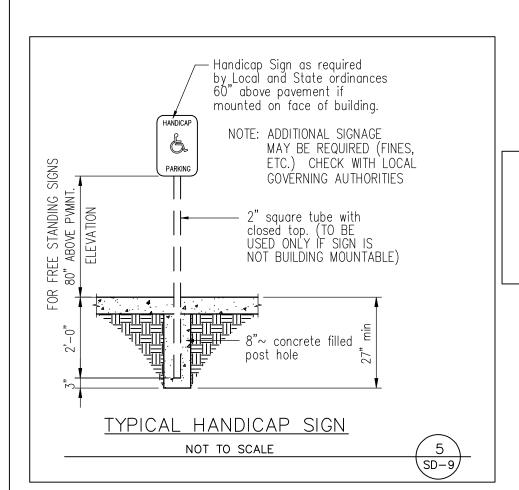


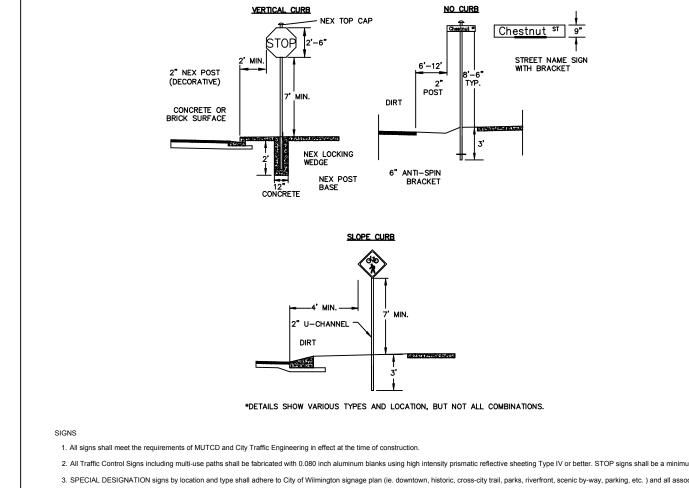



2. All Traffic Control Signs including multi-use paths shall be fabricated with 0.080 inch aluminum blanks using high intensity prismatic reflective sheeting Type IV or better. STOP signs shall be a minimum of 30"x30" 3. SPECIAL DESIGNATION signs by location and type shall adhere to City of Wilmington signage plan (ie. downtown, historic, cross-city trail, parks, riverfront, scenic by-way, parking, etc.) and all associated policies. maximum as dictated by the number of letters in the name. The color scheme shall be white letters on a green background without a border. Generally, in the downtown and historic areas or as designated in the City of Wilmington signage plan the background shall be blue and contain a topper. 5. Decorative sign posts shall consist of the NEX sign support system, 2" octagonal tube, 14 gauge, powder coated glossy black and include cap, post, base and wedge. 6. All other sign posts shall be u-channel posts made of galvanized steel with 8' posts 2lbs/ft or 12' posts 3lbs/ft. Galvanized NEX post may be substituted with approval from the City Signs and Markings Engineer. 7. OVERHEAD STREET NAME SIGNS shall be fabricated with 0.080 inch aluminum flat sign blanks 18" in height using a standard cut-out. Sign length will be dictated by the number of letters in the name. For mast-arm type traffic signal supports and other overhead support systems refer to the design plans for maximum sign length.


8. All sign lettering, colors and fonts shall adhere to the MUTCD in effect at the time of construction. Florescent Yellow-Green shall be used on signs, in place of Yellow, when listed as an optional color in the MUTCD. Generally, the font will be FHWA series fonts (Highway Gothic.) Other font types require prior City Signs and Markings Engineer approval . 9. Sign locations depend on the edge of road condition. Generally, signs shall be a minimum 2' from face of a vertical curb, 4' from front of slope face curb, and 6' from edge of pavement without curb. Signs shall not be located more than 12' from any of these locations.


10. Sign posts installed in dirt shall be buried a minimum of 36". Octagonal posts shall utilize an anti-spin device, 6" in length minimum. Sign posts installed in concrete or brick shall utilize a base cast in concrete 24" x 12" diameter. 11. Street name signs shall be installed 8'-6" from the ground to the bottom of the sign. Street name signs co-located with STOP signs shall be installed above the STOP sign. A 6" space shall be maintained between the STOP sign and a Street name sign that is parallel to the STOP sign face. All other signs should be mounted per MUTCD guidelines for Urban Areas.

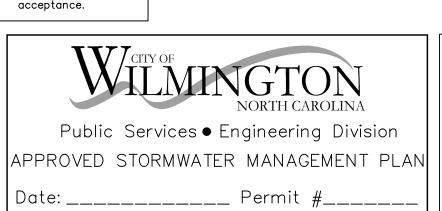

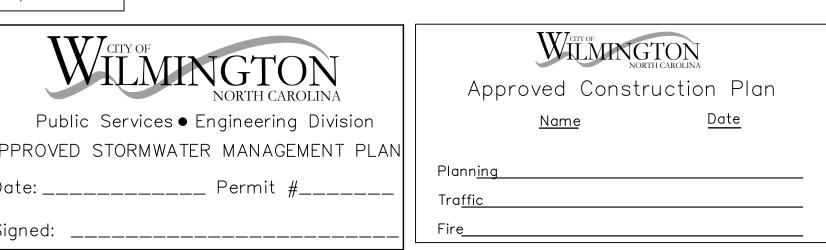

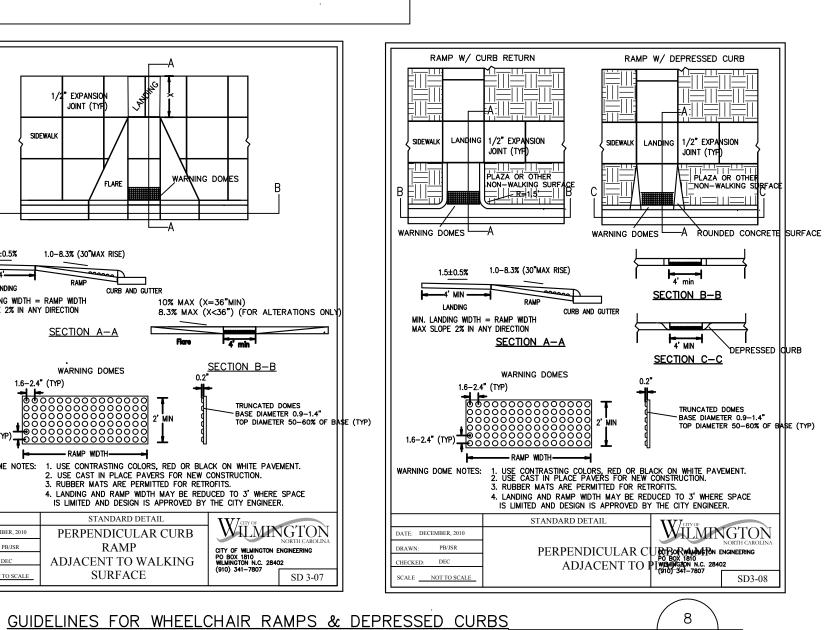

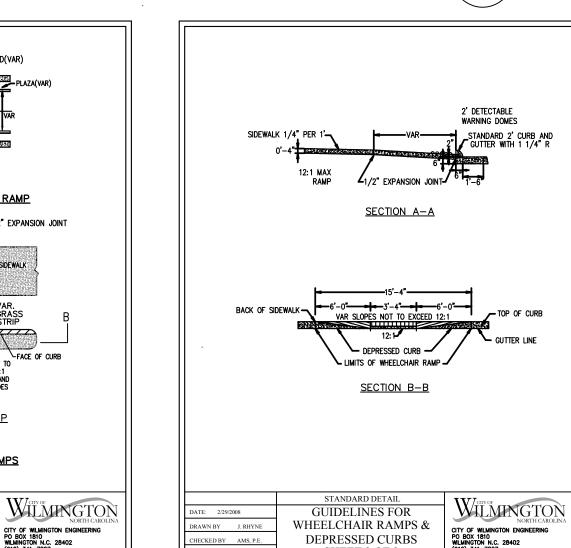

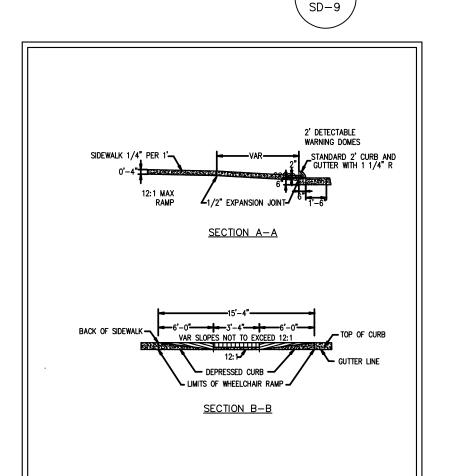


SHEET 2 OF 2


CTY OF WILMINGTON ENGINEERING
PO BOX 1810
WILMINGTON N.C. 28402
(910) 341-7807
SD 8-10


City streets, a \$325 shall be required from City prior to occupancy and/or project


For each open utility City streets, a \$325 shall be required from City prior to occupancy and/or project acceptance.



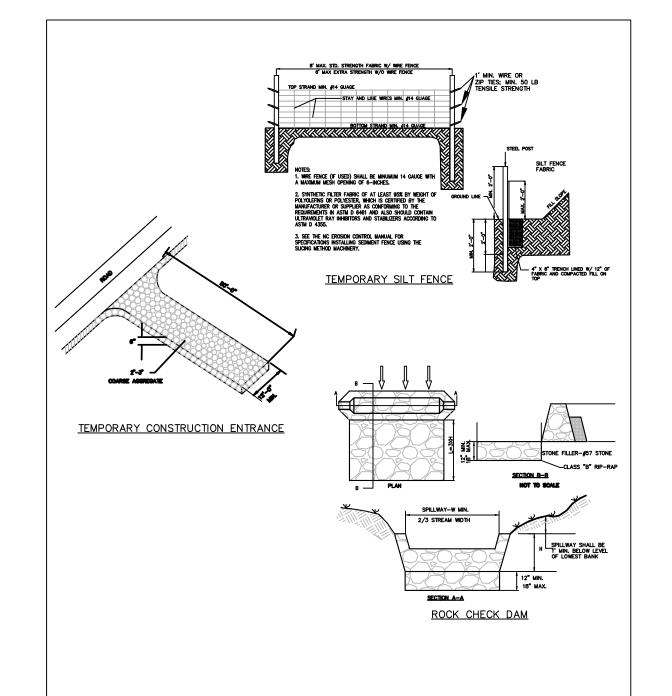

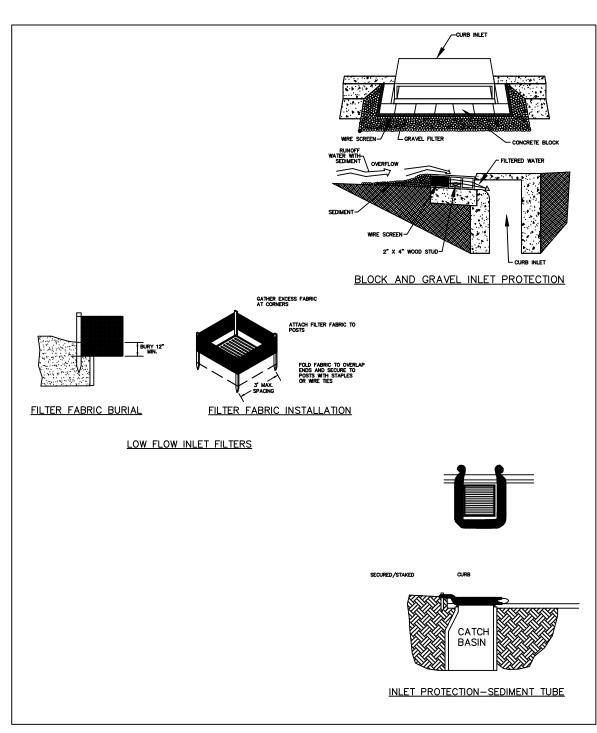


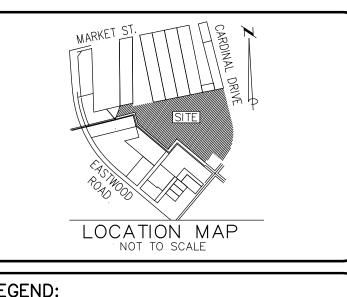

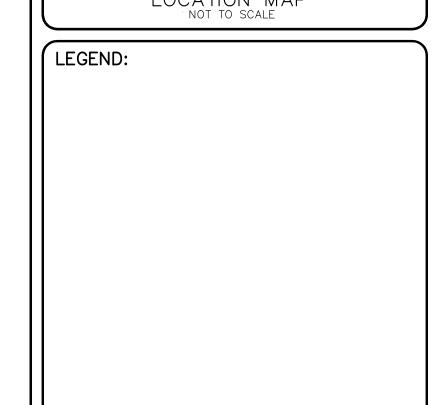

2 TRC COMMENTS 6/18/15 TREE REMOVAL, TREE PROTECTION, HC PARKING SUMMARY, TRAFFIC FACILITY INVENTORY, SW APPROVAL

REV.BY DESCRIPTION DATE REVISIONS

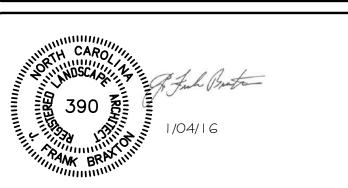

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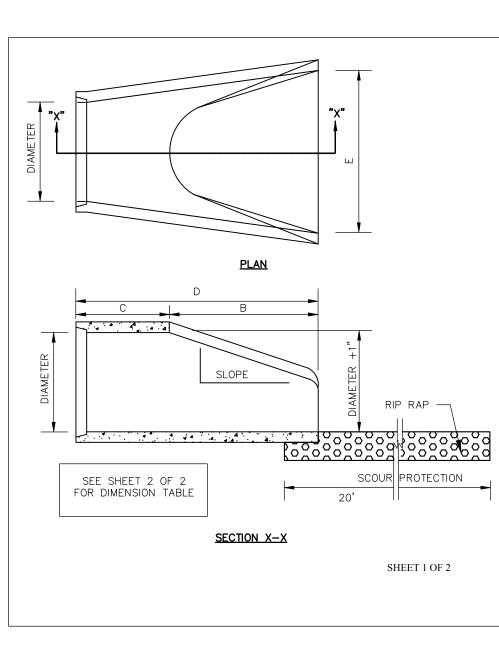
Coastal Land Design, PLLC Civil Engineering / Landscape Architecture Land Planning / Construction Management NCBELS Firm License No: P-0369 Phone: 910-254-9333 ilmington, NC 28402 www.cldeng.com Fax: 910-254-0502


DRAWN:	F.BRAXTON	PROJECT	400-01
DESIGN :	F.BRAXTON	NUMBER :	400-01
CHECK :	J.PETROFF	SCALE :	VARIES
APPROVED :	F.BRAXTON	DATE :	06/18/14
FILE NAME :	Y: \000\400-01	\dwg\SUPMO[)


OVERFLOW PARKING


PROPOSED SITE DETAILS

SHEET NUMBER SD-10



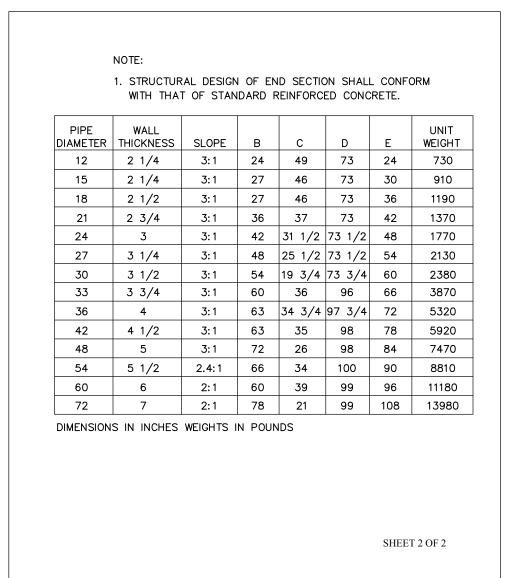

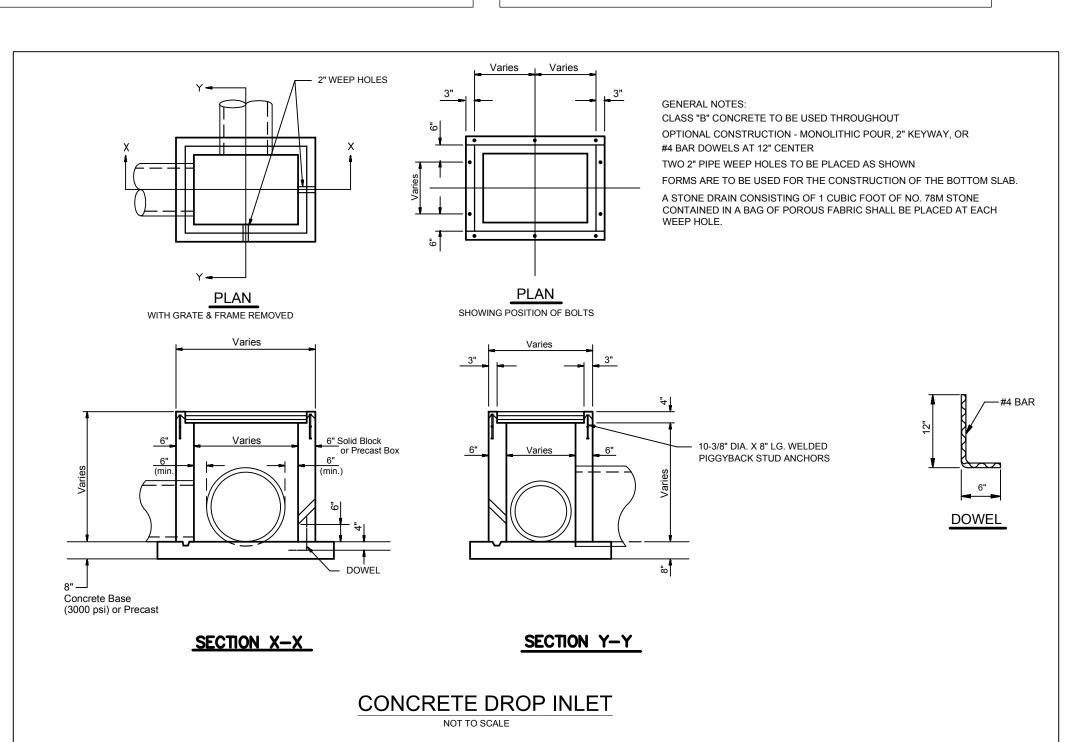

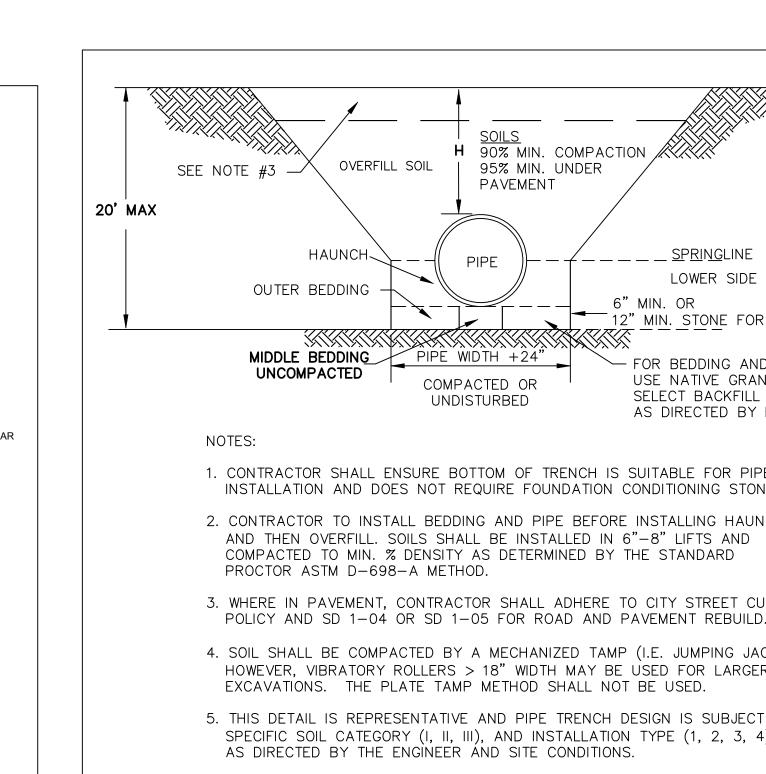

1. La IS THE LENGTH OF THE RIPRAP APRON.


2. d = 1.5 TIMES THE MAXIMUM STONE DIAMETER BUT NOT LESS THAN 6'.


3. IN A WELL - DEFINED CHANNEL EXTEND THE APRON


UP THE CHANNEL BANKS TO AN ELEVATION OF 6" ABOVE THE MAXIMUM TAILWATER DEPTH OR TO THE TOP OF THE BANK, WHICHEVER IS LESS.

4. A FILTER BLANKET OR FILTER FABRIC SHOULD BE INSTALLED BETWEEN THE RIPRAP AND SOIL FOUNDATION.

<u>PLAN</u>

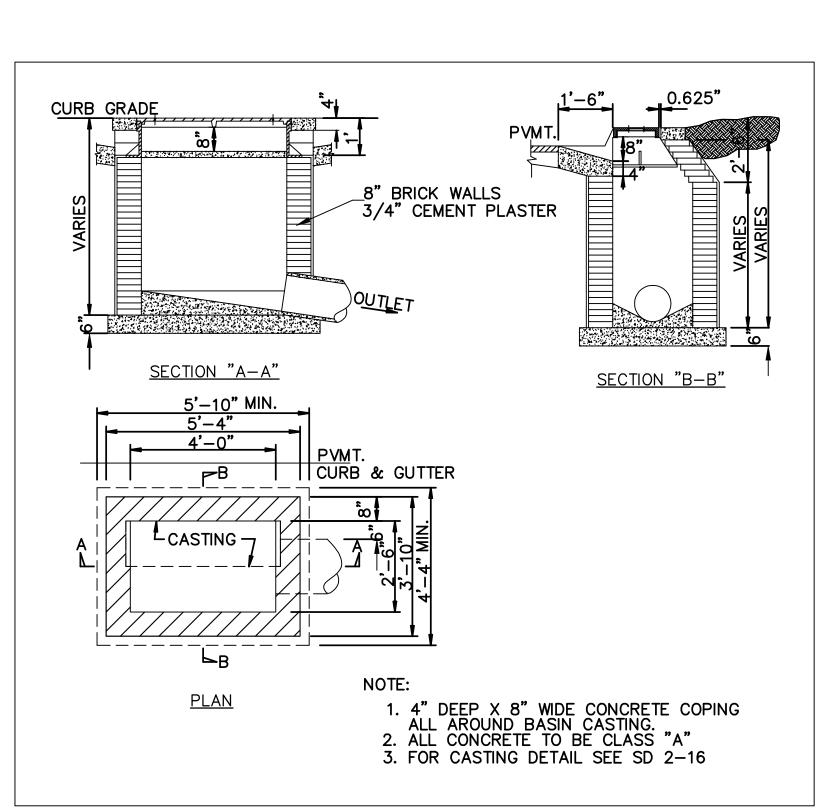


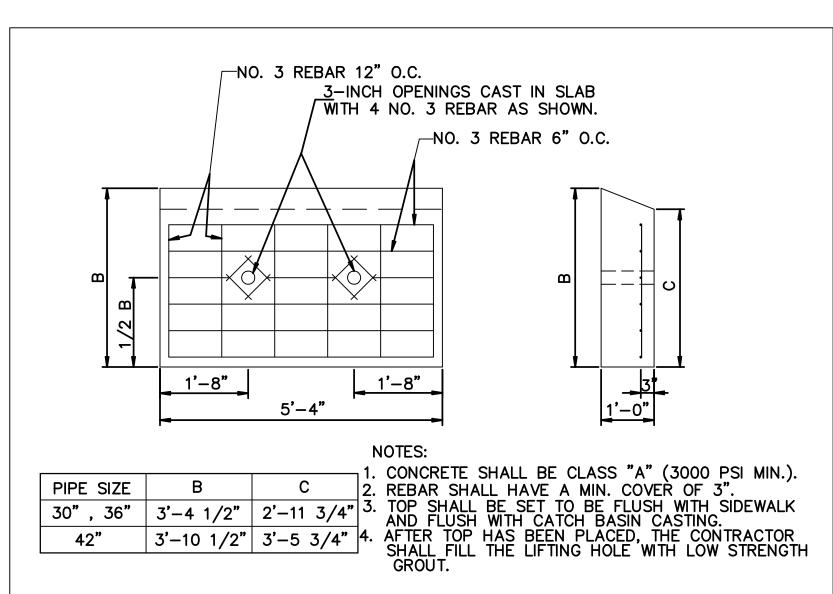

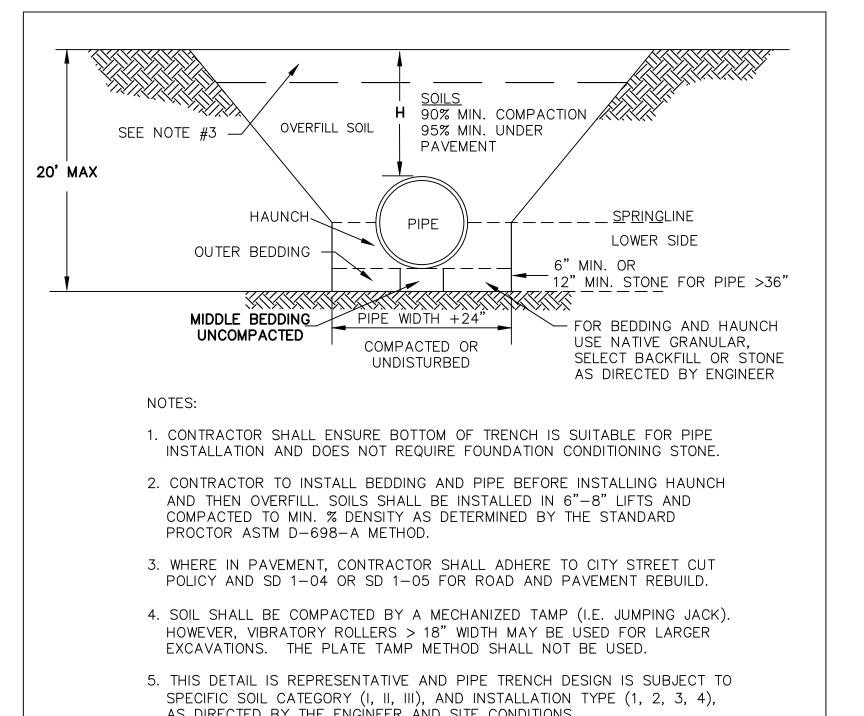

PIPE OUTLET TO FLAT AREA

NO WELL-DEFINED CHANNEL

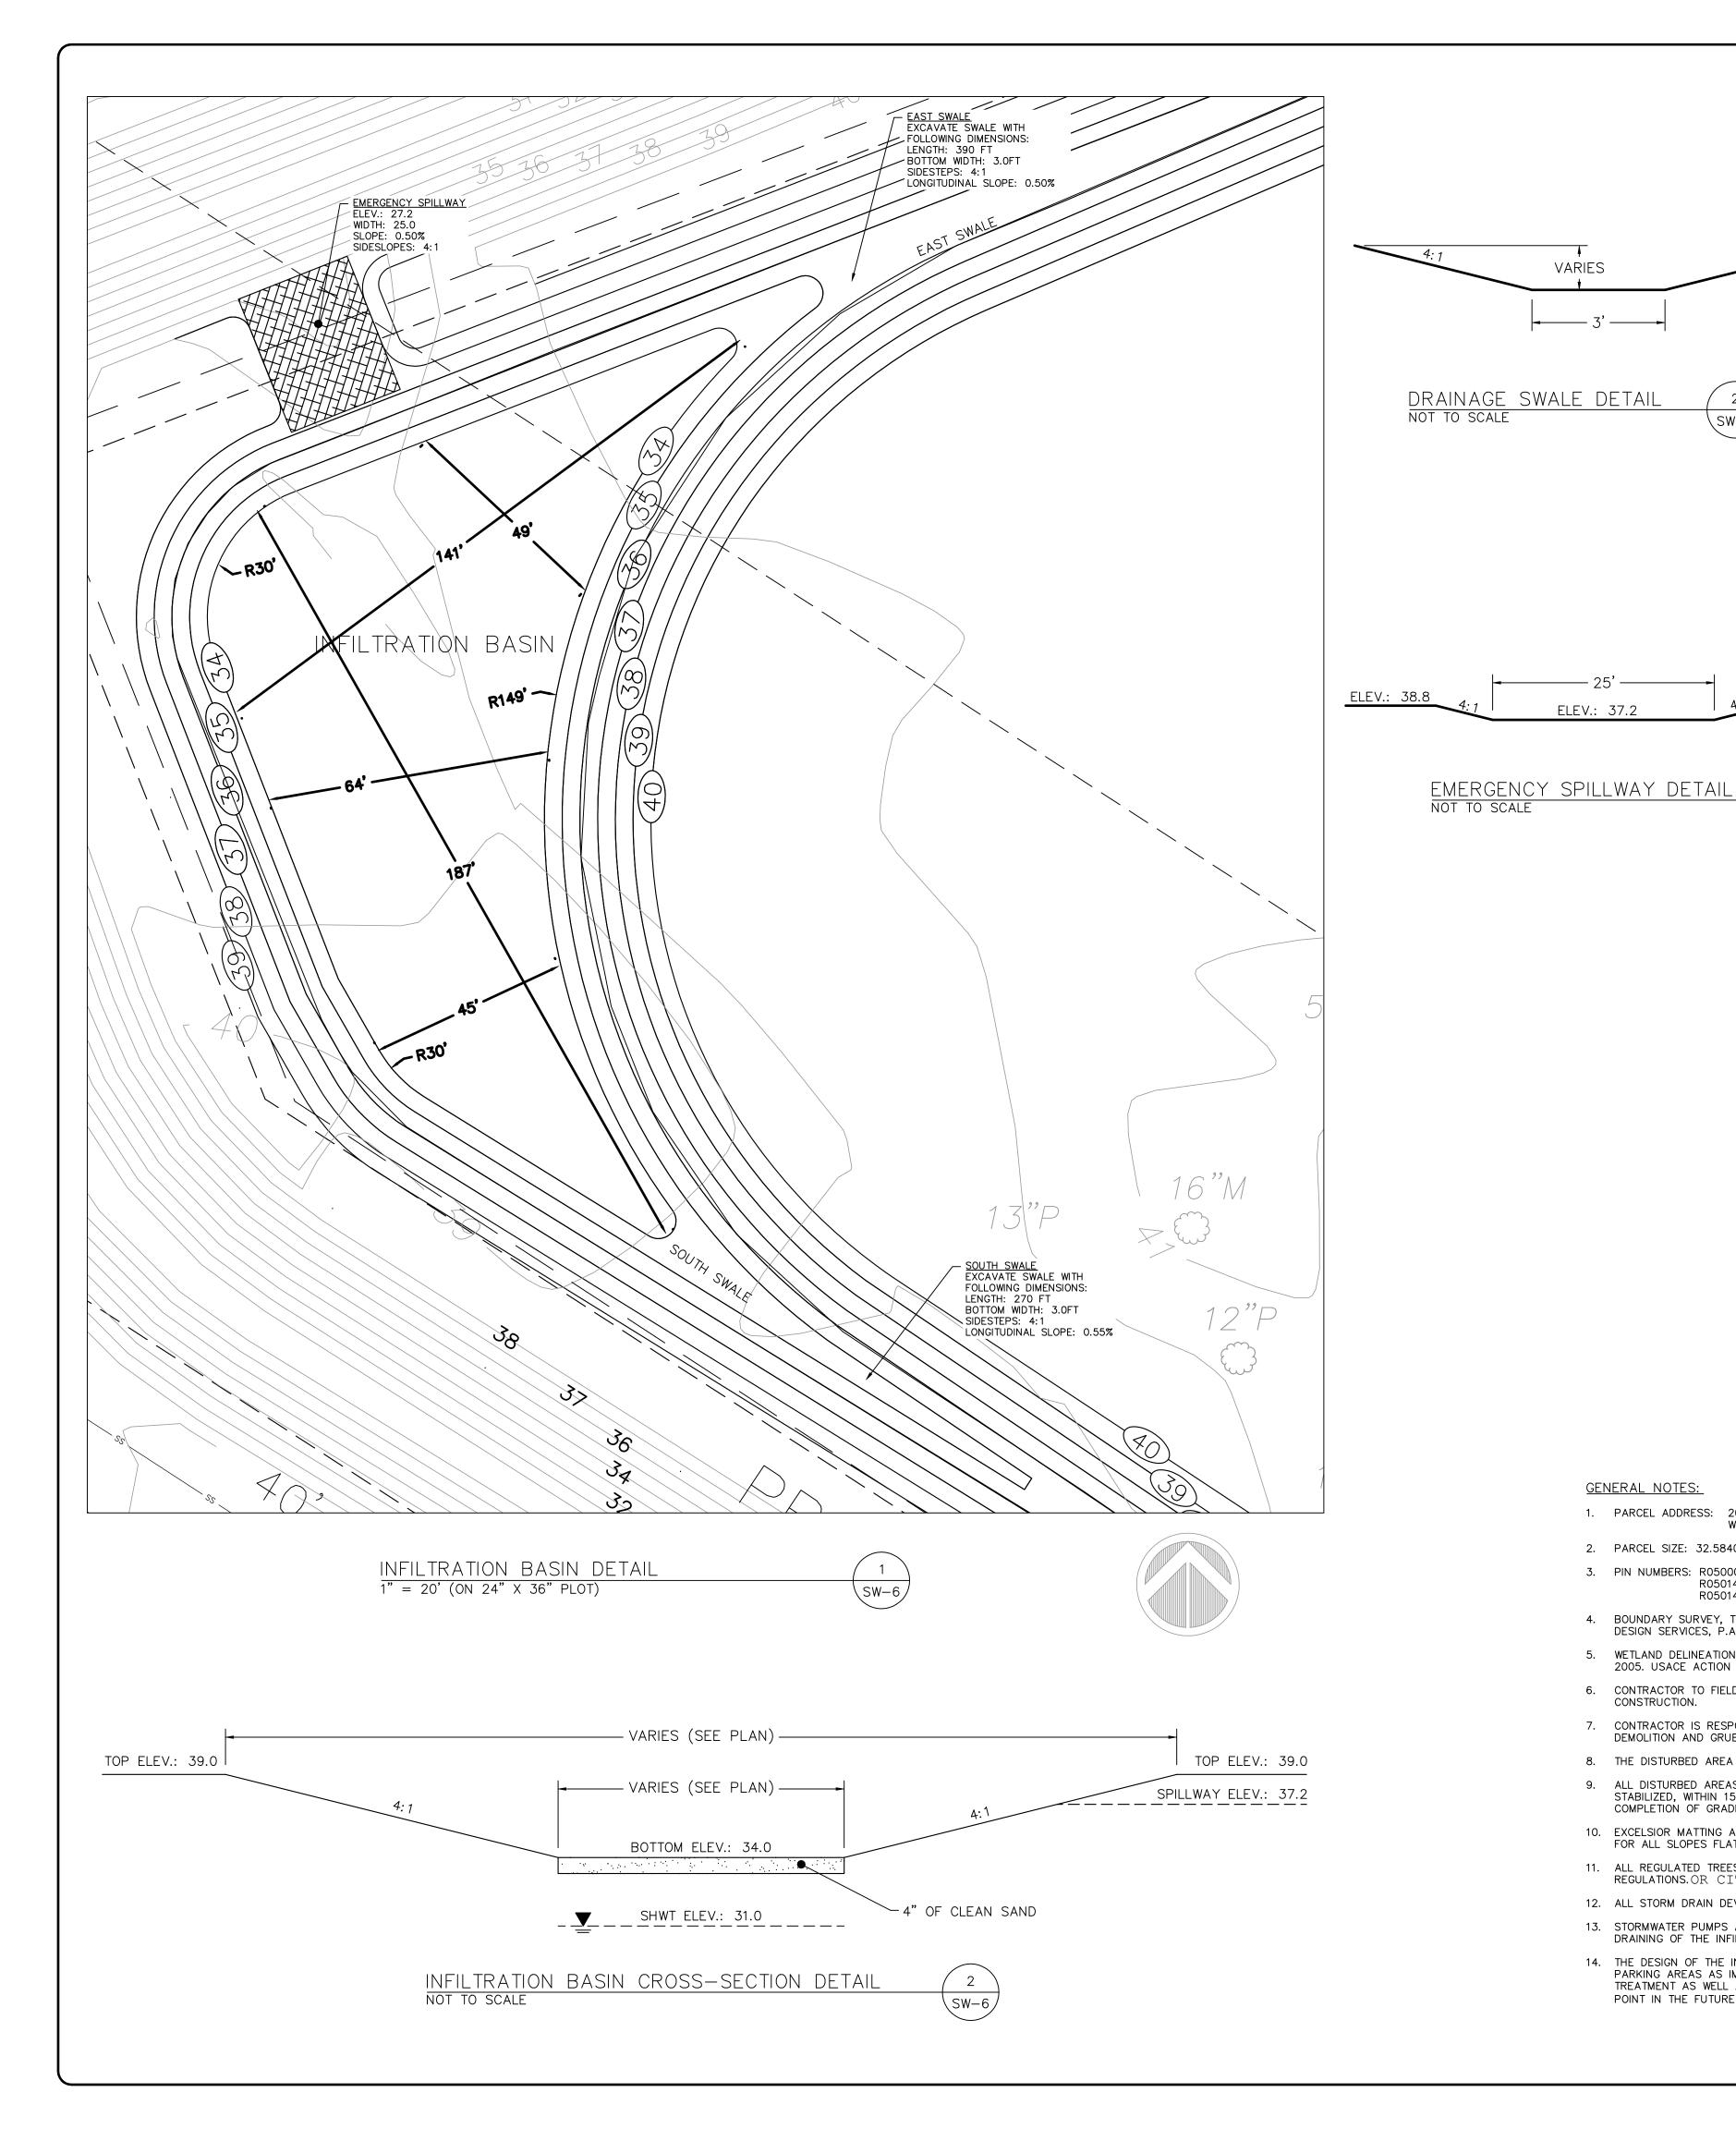

For each open utility cut of City streets, a \$325 shall be required from City prior to occupancy and/or project acceptance.

Public Services • Engineering Division APPROVED STORMWATER MANAGEMENT PLAN Date: _____ Permit #____

WILMINGTON NORTH CAROLINA

Approved Construction Plan <u>Date</u>

BASIN #2 BUA TABLE

= 371,642 SF

= 89,265 SF

= 17,370 SF

= 108,025 SF

= 1,390 SF

= NONE

= NONE

= NONE

= NONE

OVERALL AREA

TOTAL BASIN AREA

IMPERVIOUS AREA

ON-SITE BUILDINGS

ON-SITE STREETS

ON-SITE PARKING

ON-SITE SIDEWALK

OTHER ON-SITE

ON-SITE FUTURE

BASIN DENSITY

 $\frac{108,025 \text{ SF}}{371,642 \text{ SF}} (100) = 29.1 \%$

GENERAL CONSTRUCTION SEQUENCE:

ORIGINAL DESIGN DIMENSIONS.

INSTALL TREE PROTECTION FENCING PER APPROVED PLANS.

EXCAVATE STORMWATER POND AND CONVEYANCE SWALES.

DRIVEWAYS SHOULD BE USED AS MUCH AS POSSIBLE ..

CLEAR, GRUB, AND GRADE SITE WITH CARE TO LIMIT VEHICULAR TRAFFIC ON AREA FOR GRASSED PARKING LOT. THE ASPHALT

AFTER ALL LAND DISTURBING ACTIVITIES IS COMPLETE, AND THE

BASIN IS ADEQUATELY STABILIZED, THE SEDIMENT FENCE SHALL

BE REMOVED AND THE POND SHALL BE CLEANED OUT TO THE

INSTALL SEDIMENT FENCE PER APPROVED PLANS.


OFF-SITE

LEGEND:

LOCATION MAP

2 TRC COMMENTS 6/18/15 TREE REMOVAL, TREE PROTECTION, HC PARKING SUMMARY, TRAFFIC FACILITY INVENTORY, SW APPROVAL

REV.BY DESCRIPTION DATE REVISIONS

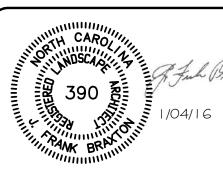

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F.BRAXTON	PROJECT	400-01
F.BRAXTON	NUMBER :	400-01
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F.BRAXTON	DATE:	06/18/14
Y: \000\400-01	\dwg\SUPMOE)
	F.BRAXTON J.PETROFF F.BRAXTON	F.BRAXTON NUMBER: J.PETROFF SCALE:

OVERFLOW PARKING

STORMWATER PLAN

SD-11

GENERAL NOTES:

VARIES

ELEV.: 37.2

1. PARCEL ADDRESS: 200 CARDINAL DRIVE EXTENSION WILMINGTON, NORTH CAROLINA 28405

2. PARCEL SIZE: 32.5840 ACRES.

4. BOUNDARY SURVEY, TOPOGRAPHIC SURVEY, AND WETLAND SURVEY WERE COMPLETED BY HANOVER DESIGN SERVICES, P.A AND WERE INCLUDED IN THE ORIGINAL SUBMITTAL FOR THIS PROJECT.

5. WETLAND DELINEATION HAS BEEN APPROVED BY THE U.S. ARMY CORPS OF ENGINEERS ON APRIL 8,

7. CONTRACTOR IS RESPONSIBLE FOR DISPOSAL OF ALL WASTE MATERIALS GENERATED THROUGH

ELEV.: 39.0

9. ALL DISTURBED AREAS ARE TO BE SEEDED, FERTILIZED, AND MULCHED, OR ELSEWISE ADEQUATELY STABILIZED, WITHIN 15 WORKING DAYS OR 30 CALENDAR DAYS, WHICH EVER IS SHORTER OF COMPLETION OF GRADING ACTIVITIES.

10. EXCELSIOR MATTING AND SEEDING TO BE USED ON SLOPES STEEPER THAN 2:1. SOD SHALL BE USED FOR ALL SLOPES FLATTER THAN 2:1.

11. ALL REGULATED TREES IN DISTURBED AREA ARE TO BE PROTECTED AS PER NEW HANOVER COUNTY REGULATIONS.OR CITY OF WILMINGTON REGULATIONS.

DRAINING OF THE INFILTRATION BASIN.

PARKING AREAS AS IMPERVIOUS AREA. HENCE, IT IS PURPOSELY OVERDESIGNED TO PROVIDE ADDITIONAL TREATMENT AS WELL AS TO PROVIDE AN OPTION FOR THE GRASSED AREA TO BE PAVED AT SOME POINT IN THE FUTURE (NOT INCLUDED IN THIS PROJECT).

3. PIN NUMBERS: R05000-002-0004-000 R05014-002-001-000 R05014-002-002-000

2005. USACE ACTION ID: 200500598. THERE ARE NO WETLAND IMPACTS FOR THIS PROJECT.

6. CONTRACTOR TO FIELD VERIFY ALL EXISTING UTILITIES ABOVE AND BELOW GROUND BEFORE COMMENCING

DEMOLITION AND GRUBBING ACTIVITIES SHOWN.

8. THE DISTURBED AREA FOR THE CONSTRUCTION OF THIS MODIFICATION IS 12.5 ACRES.

12. ALL STORM DRAIN DEVICES ARE DESIGNED TO PROVIDE POSITIVE DRAINAGE.

13. STORMWATER PUMPS ARE TO BE PROVIDED OR TO BE READILY AVAILABLE IN CASE OF EMERGENCY

14. THE DESIGN OF THE INFILTRATION BASIN IS BASED UPON THE CONSIDERATION OF THE GRASSED

